


MAGNOLIA 6-PLEX

30535 SW Magnolia Ave Wilsonville, OR 97070

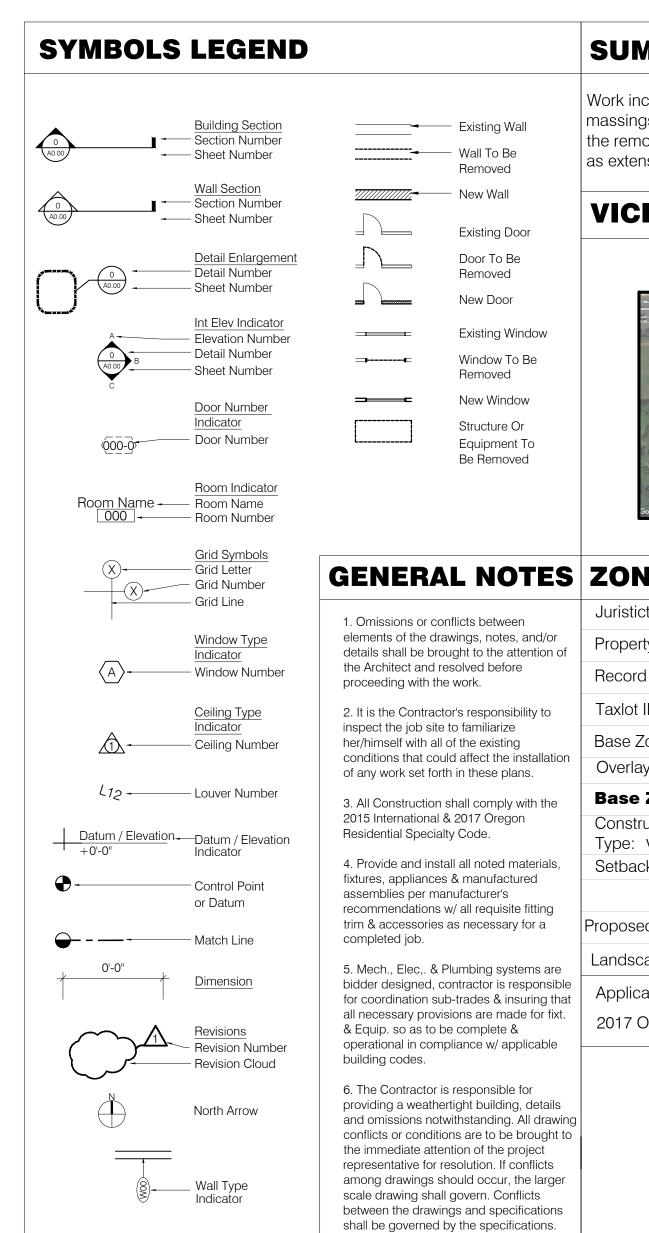



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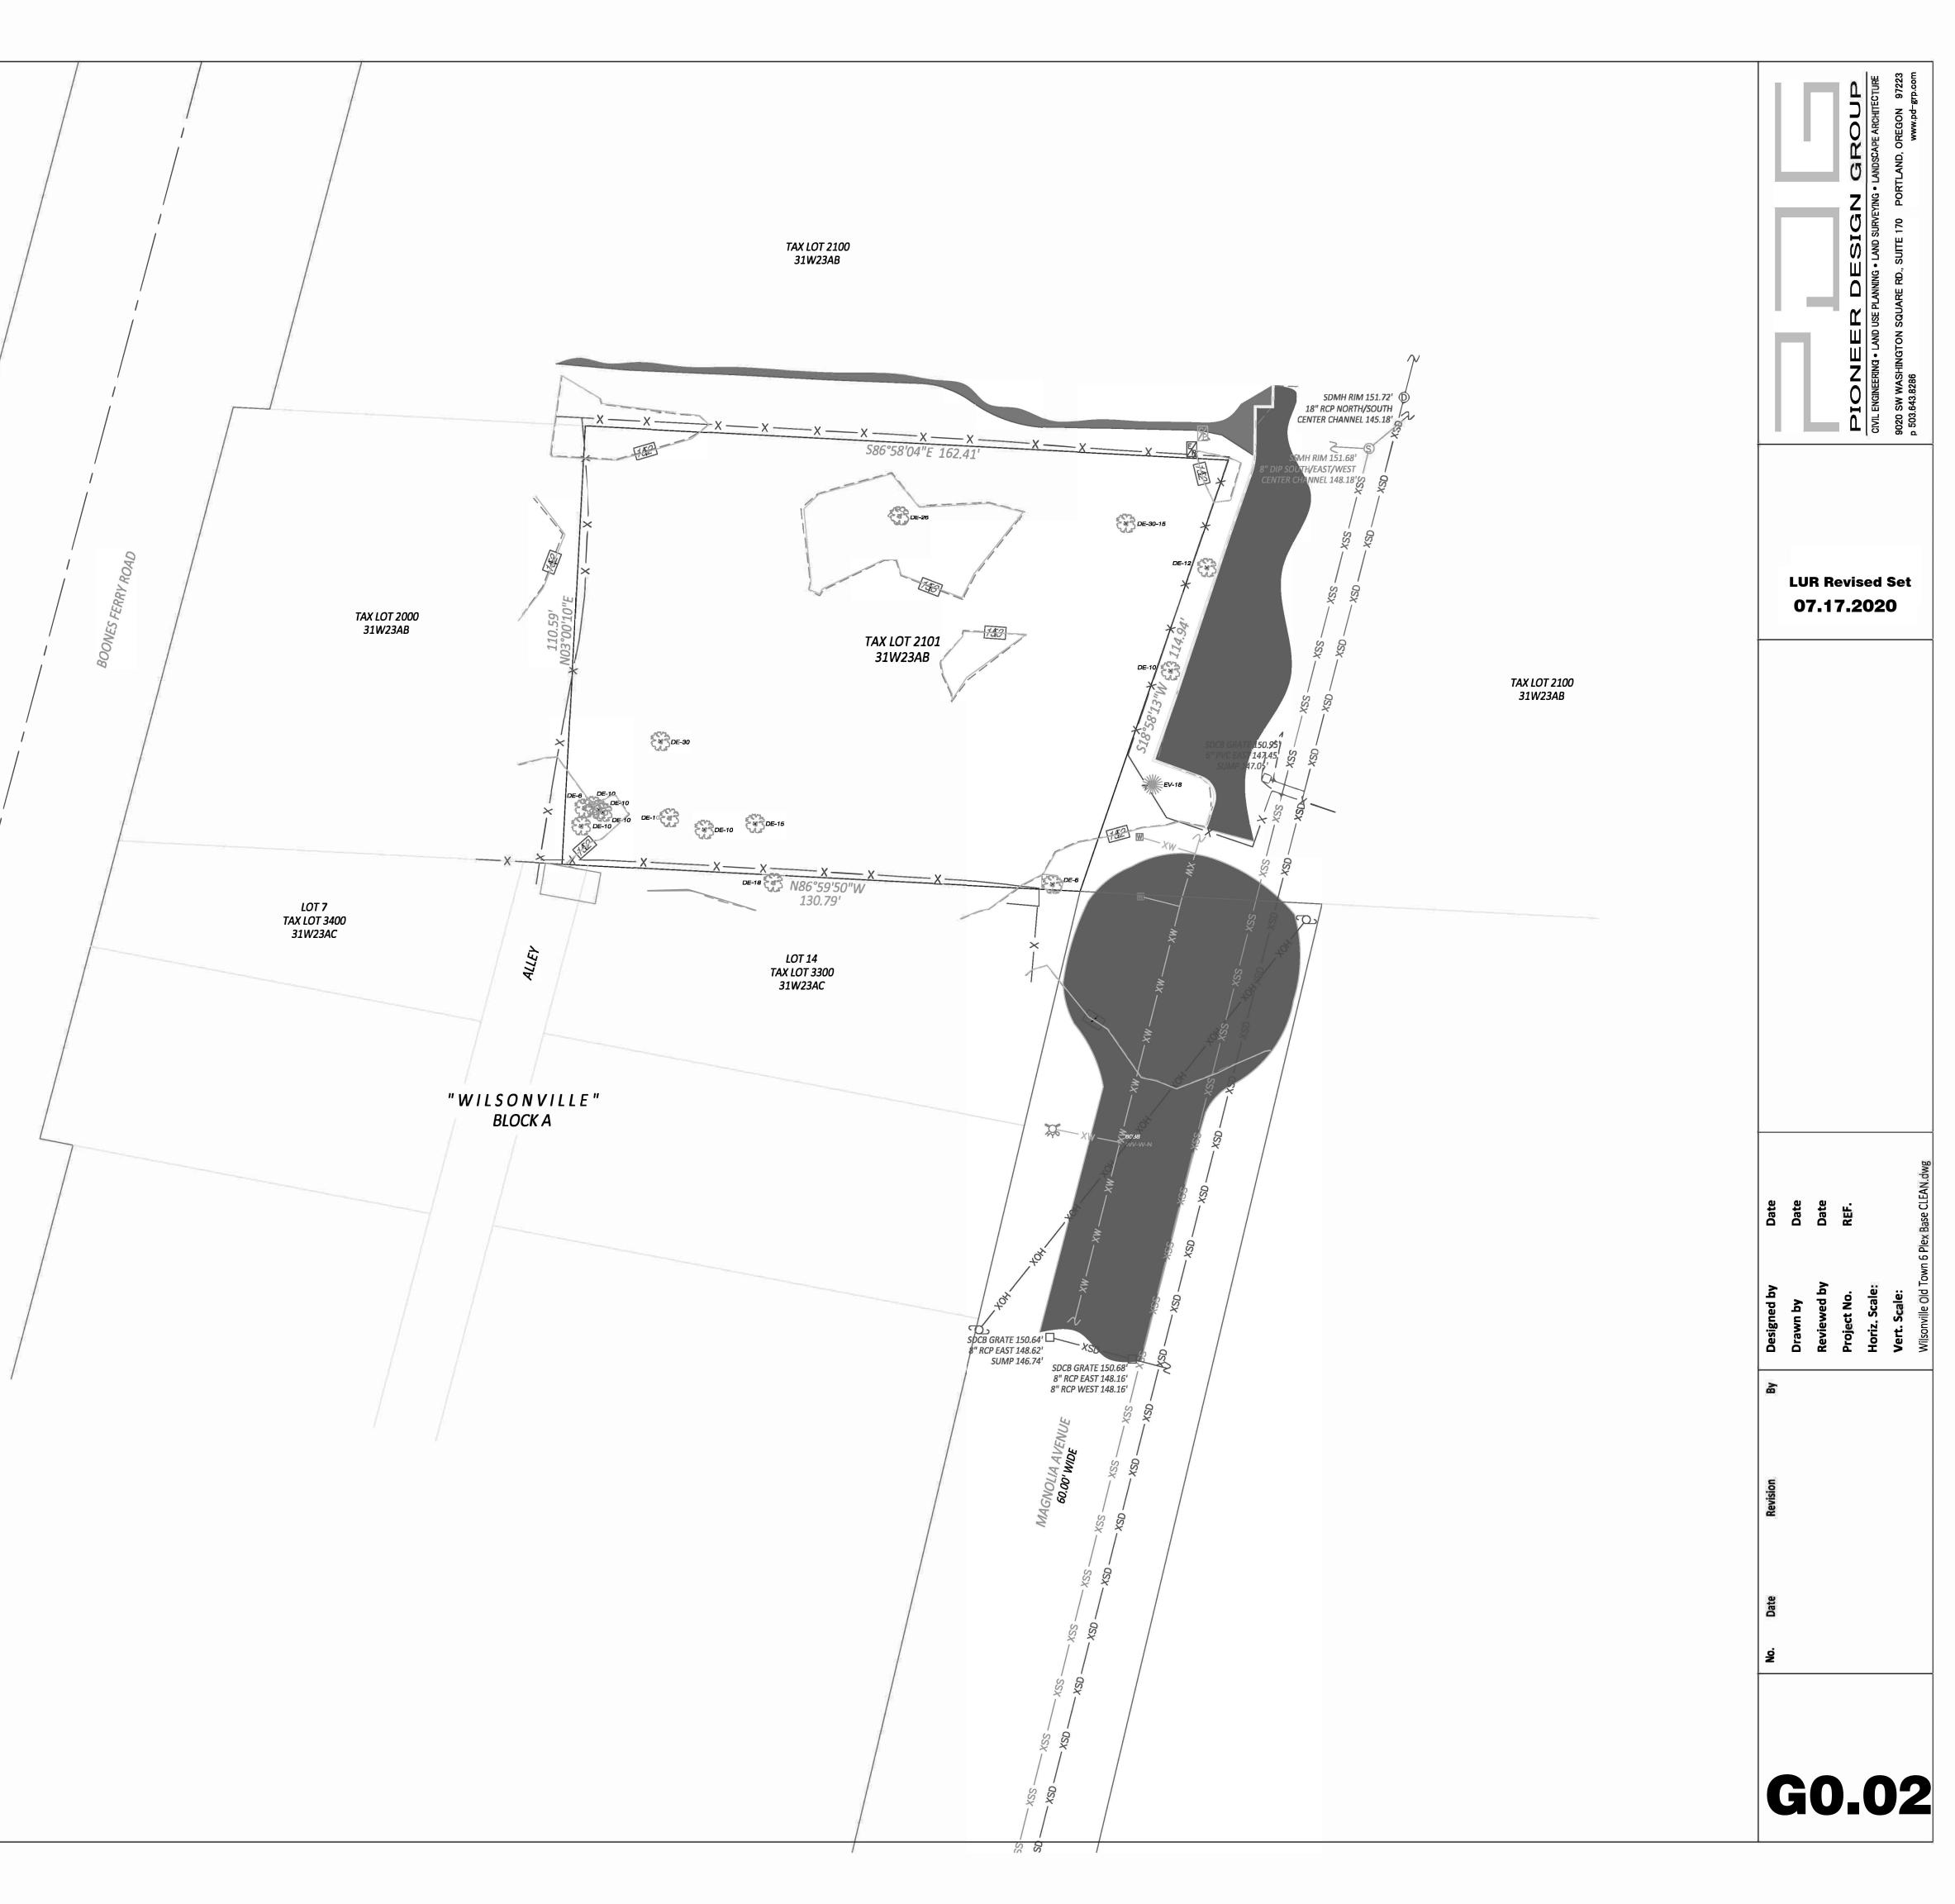
> LUR Revised Set 07.17.2020

Revision Date: Issue:

permission.

MMA	RY OF SCOPE C	F WORK	DR/	WING INDEX							
ings consis moval of e	he construction of a (6) 3-story st of (2) buildings on the site. T existing trees per an arborist's re e work and new tree plantings.	he work also includes	GENERAL: G0.01 General Information G0.02 Site Survey								
CINIT	Y MAP	SITE	ARCHI ^T A0.01 A2.01 A2.02 A2.03 A2.04 A2.04 A2.10 A3.00 A3.01 A3.02 A3.03 CIVIL: P3.0 P3.1 P4.0 P5.0	TECTURAL: Proposed Site Plan Proposed Ground Floor Plan Proposed Second Floor Plan Proposed Third Floor Plan Proposed Roof Plan Proposed Ext. Lighting Plan Exterior Elevations Exterior Elevations Exterior Elevations Exterior Elevations Exterior Elevations Tree Removal and Protection Tree Preservation Table Grading and Erosion Utility Plan	AGNOLIA 6-F 5 SW Magnolia Avenue inville, OR 97070						
NING	SUMMARY		LANDS	-							
tictional A	uthority: Wilsonville Planning and L	and Development Ordinence									
erty Size:	16,204 SQFT		L1.01 L2.01	Landscape Area Plan Landscape Plan							
ord Numbe	er(s): 819449		L3.01	Plant Material List	Z						
ot ID: 31W	V2AB02101		DDC		0						
Zone: PE	DC Planned Landuse: Mult	i-Family			RMAT						
	Town Neighborhood		Archit	ect: Kegan Flanderka Base Design + Architecture, LLC							
	Regulations:		_	233 NE 28th Avenue Portland OR 97232	Ž						
struction	Max. Coverage: 2,949 sqft	Max. Height: 35 Ft.	_	tel 503.477.8268 kegan@basedesignarchitecture.com	O						
e: VB backs:	Front: 20 Ft.	Back: 20 Ft.		ent: Daniel Hillebrand	Ĭ						
achs.	Side 1: 10 Ft.	Garage:10 Ft.	_	8908 SE 55th Avenue Portland OR 97203	Ζ						
sed Uses:		-	_	dhillebrand11@msn.com	_		4				
			C	Vivil: Luke Lappin			006				
	quirements: 25% Open Space N	Ainimum	-	Pioneer Design Group, Inc. 9020 SW Washington Square Road Suite 170			0.				
icable Coo 7 OREGON	des: N RESIDENTIAL SPECIALTY CO	DDE (ORSC)		Portland, OR 97223 LLappin@pd-grp.com 503-643-8268	ite:	g Scale:	BASE Job No: 19004				
			Landsca	APE: Kate Holmquist Werkstadt Urban Planning + Development kate@werkstadt.org	BASE Jo Speet Tritle BASE Jo Speet Numper:						
			a j	City of Wilsonville Exhibit B2 DB19-0047 et seq	GC).()1				

AN MA





SITE INFORMATION/COVERAGE:

Property / Lot Area:	16,204 sf
Units: 6 Townhomes Gross Building Area: 10,620 Net Rentable Area: 10,620	
Building A Footprint: Building B Footprint: Total Building Footprint:	1,781.8 sf 1,711.3 sf 3,493.1 sf
Impervious Hardscape: Sidewalk: Path and Play Area: Patios: Drive + Driveway: Total Impervious Hardscape:	306.7 sf 1,400 sf 911.7 sf 4,907.8 sf 7,526.2 sf
Pervious Landscape: Raised Planters: Lawn and Lower Planters: Flow-through Planters: Total Pervious Landscape:	121 sf 4,709.4 sf 354 sf 5,184.4

SITE PLAN NOTES:

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Existing Driveway for — Single-Family Residence

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- A. All Property Information and Dimensions Shown Are Approximate and Are To Be Field Verified.
- B. Site Utilities Shown for Reference Only. Refer to Civil for exact locations
- C. Reference Civil For Erosion Control Information D. Reference Landscape for Tree Species and planting plan
- All Flow-Through Planter and Stormwater Management Areas are Approximate, Reference Civil for Stormwater Areas and Treatment Locations.



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Revision	
Date:	lssue:


SITE PLAN SYMBOLS LEGEND:


XX	Property Line Fence Building / Wall to Be Demolished Curb Line Water Line Storm Line
G ОН Т	Sewer Line Underground Gas Line Overhead Power Line Telephone Line
	Storm Catch Basin
D	Manhole
$\mathcal{O}^{\mathcal{O}}$	Power Pole
	Power Pole with Light
	Sign
~~~~~~~~~~~~~~~~~~~~~~~~~~~~~~~~~~~~~~	Fire Hydrant
WM	Water Meter
EM	Electric Meter
GMO	Gas Meter
-	Property Corner
•	Bollard





SITI

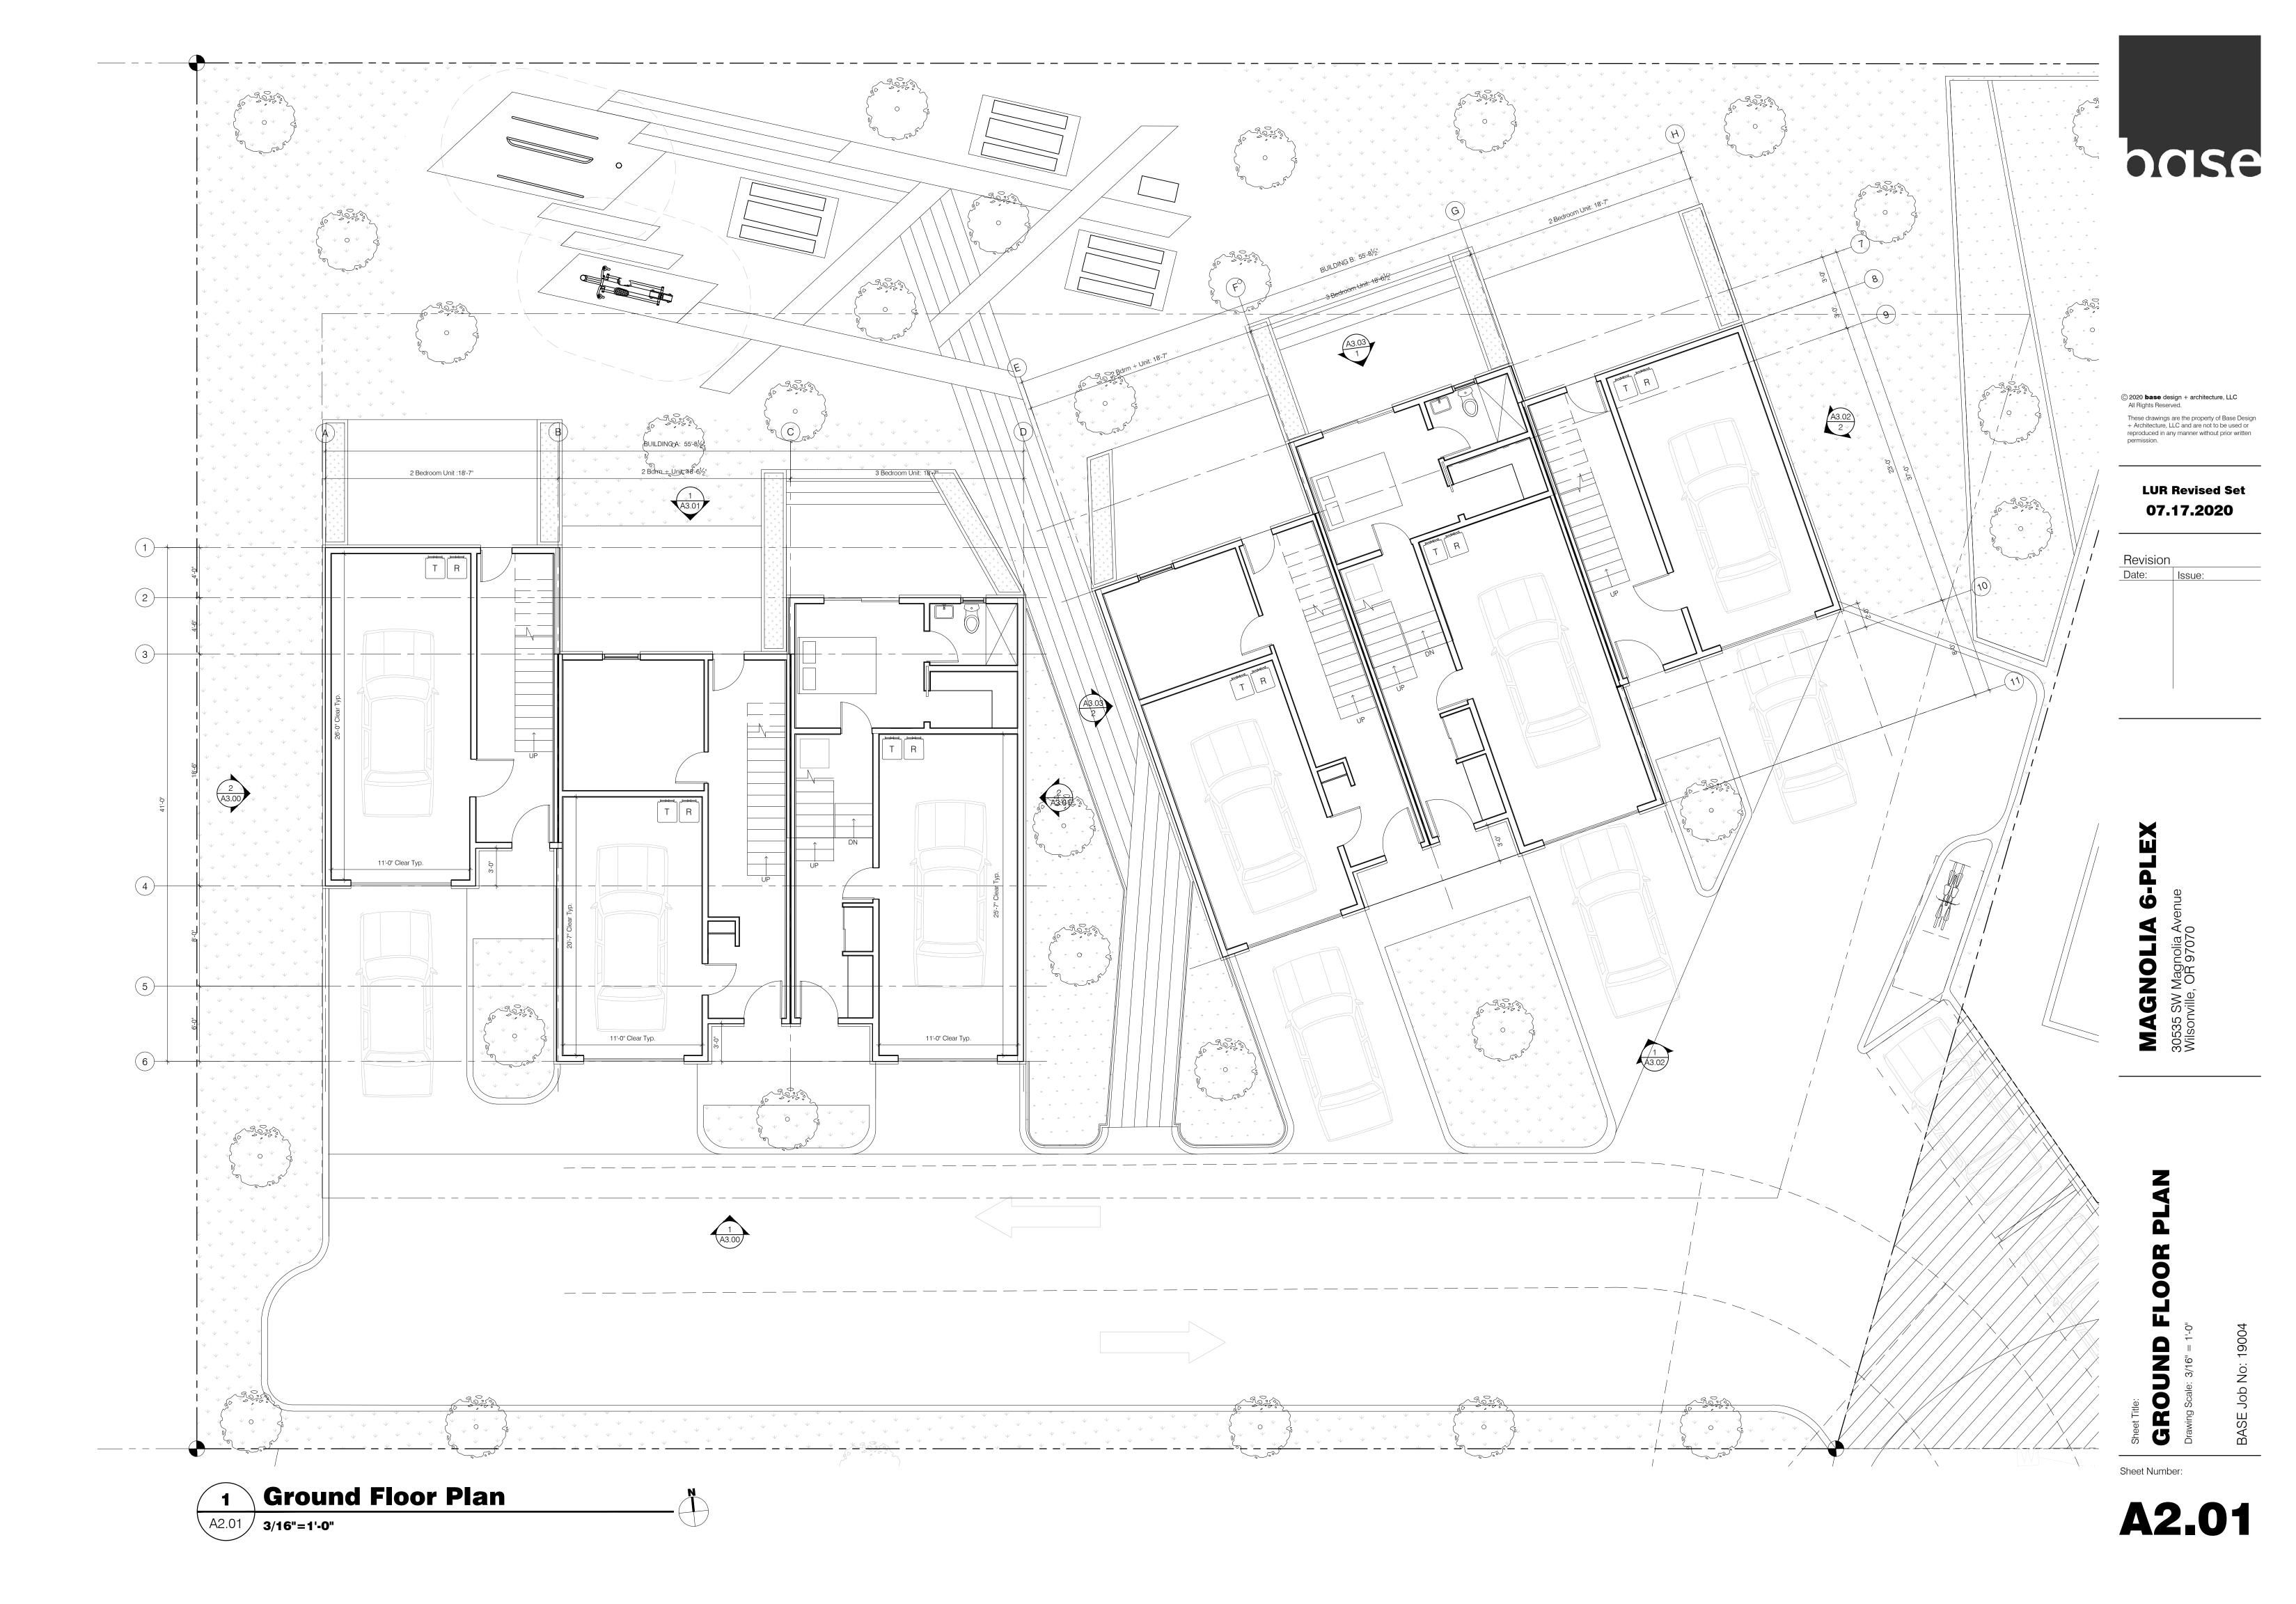

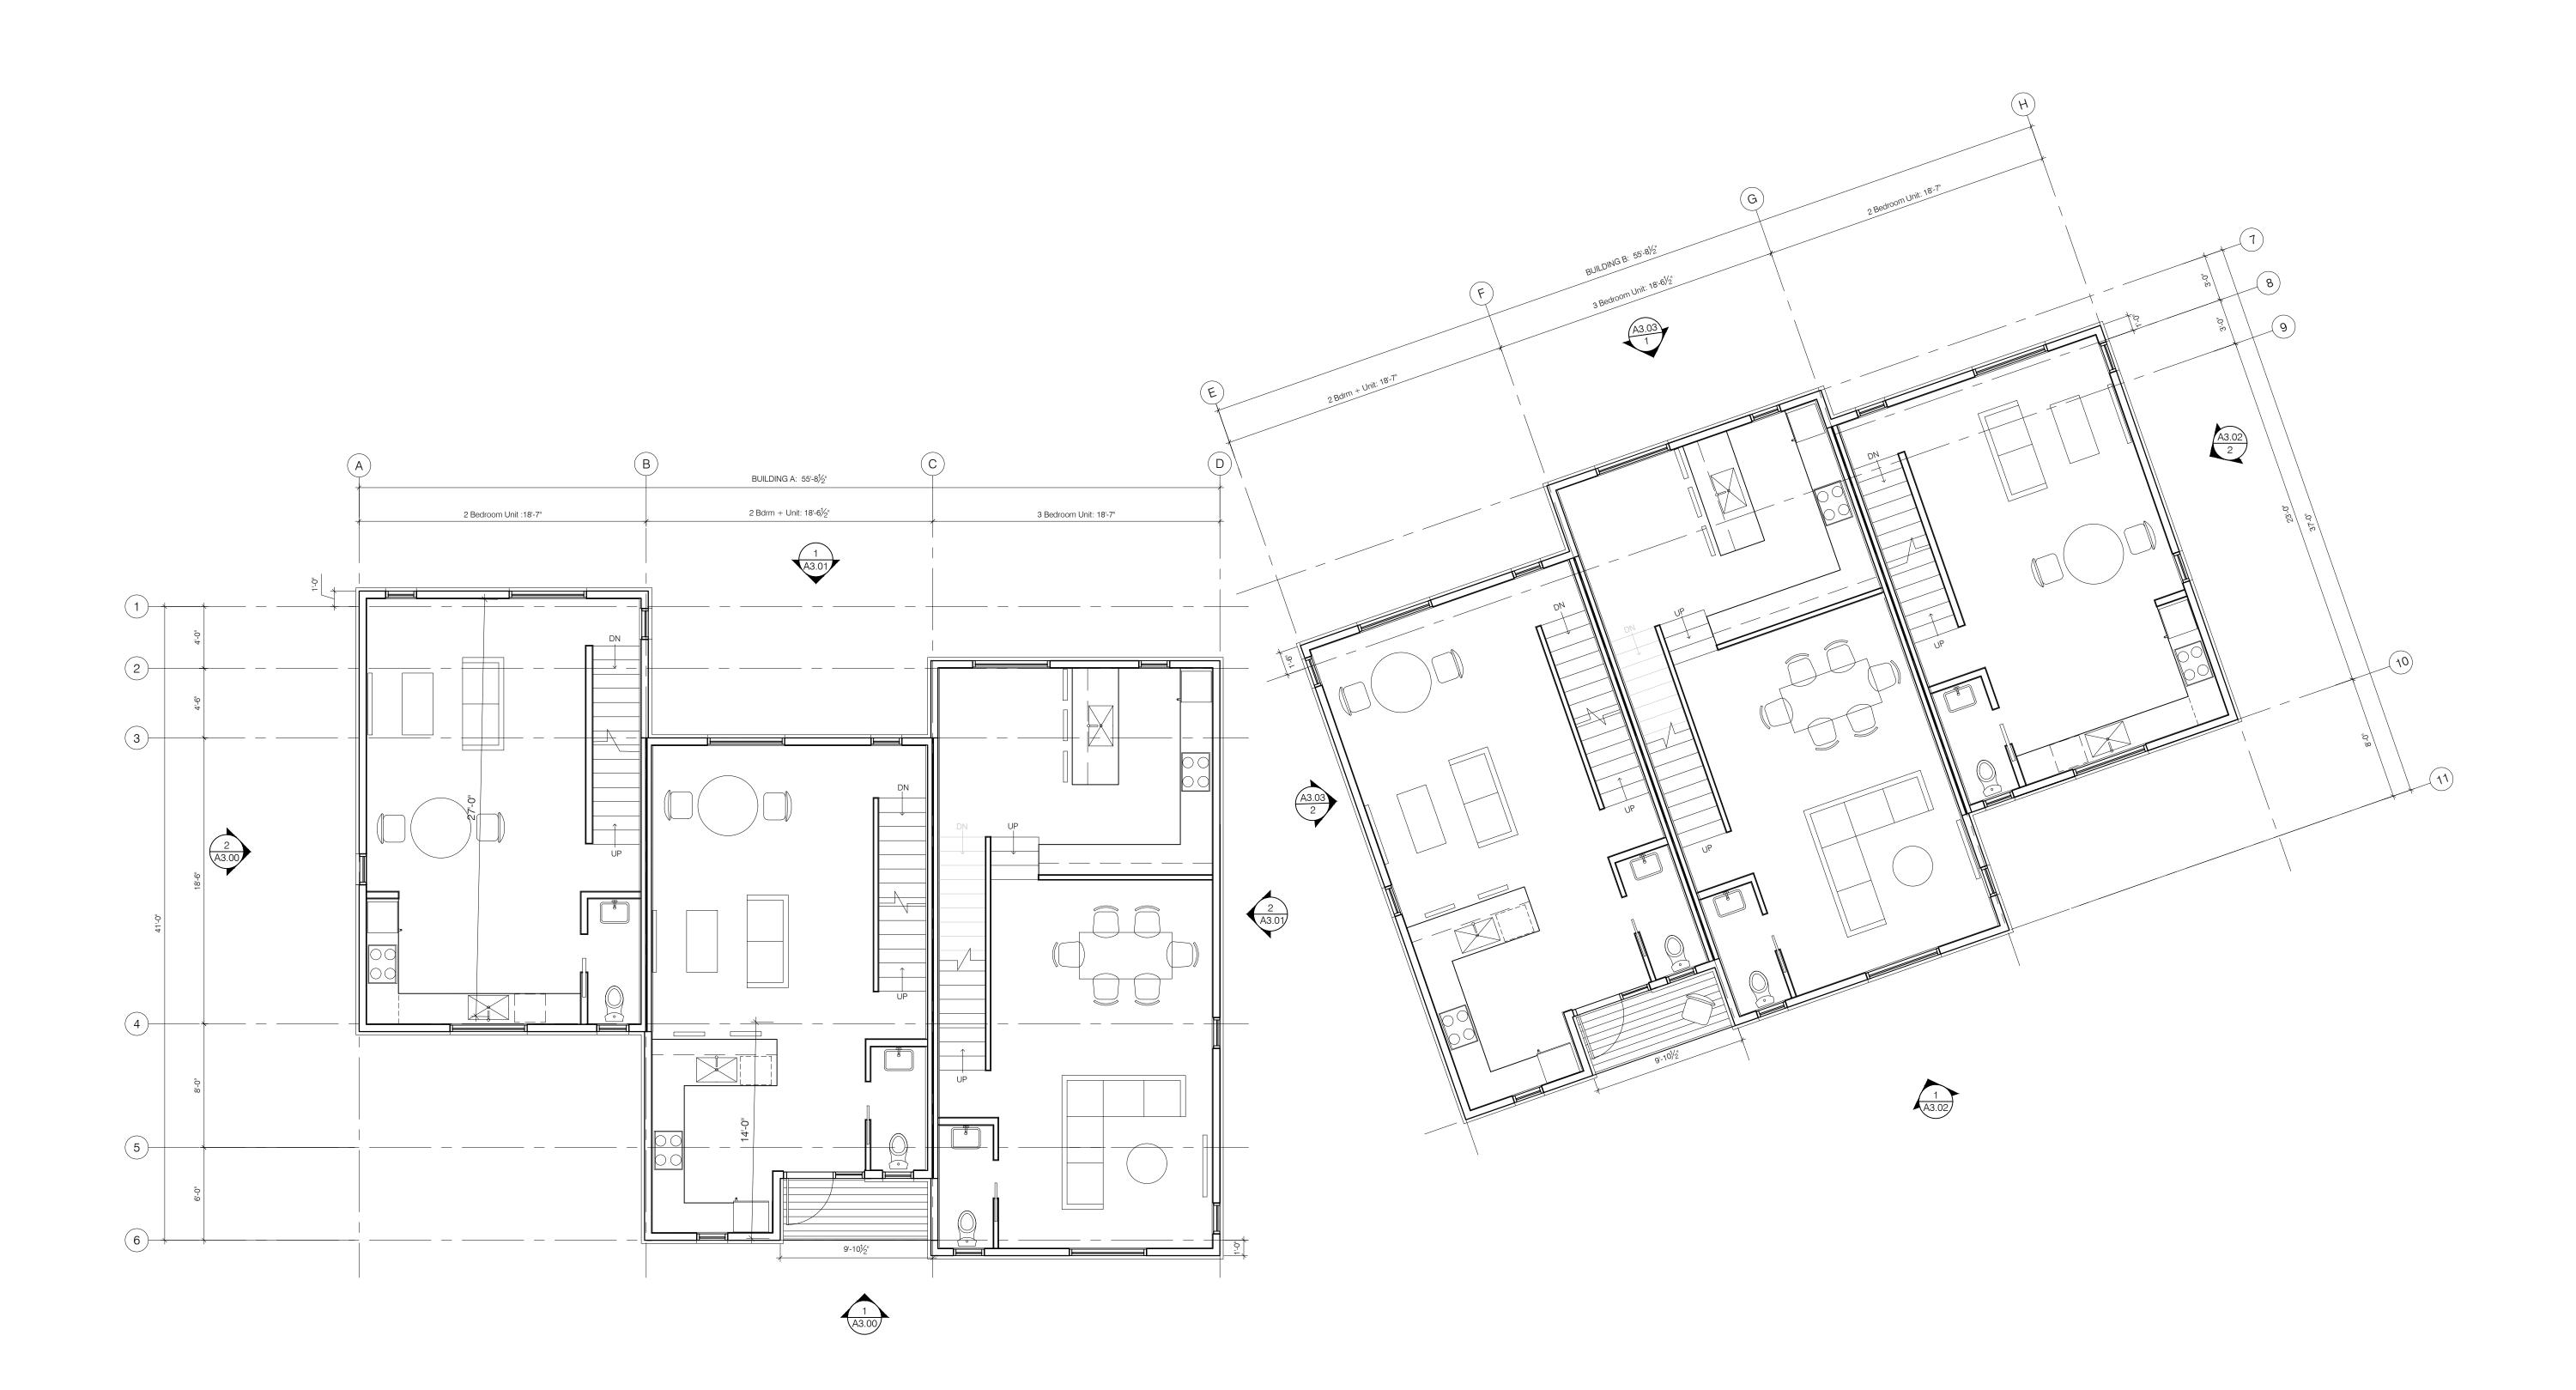





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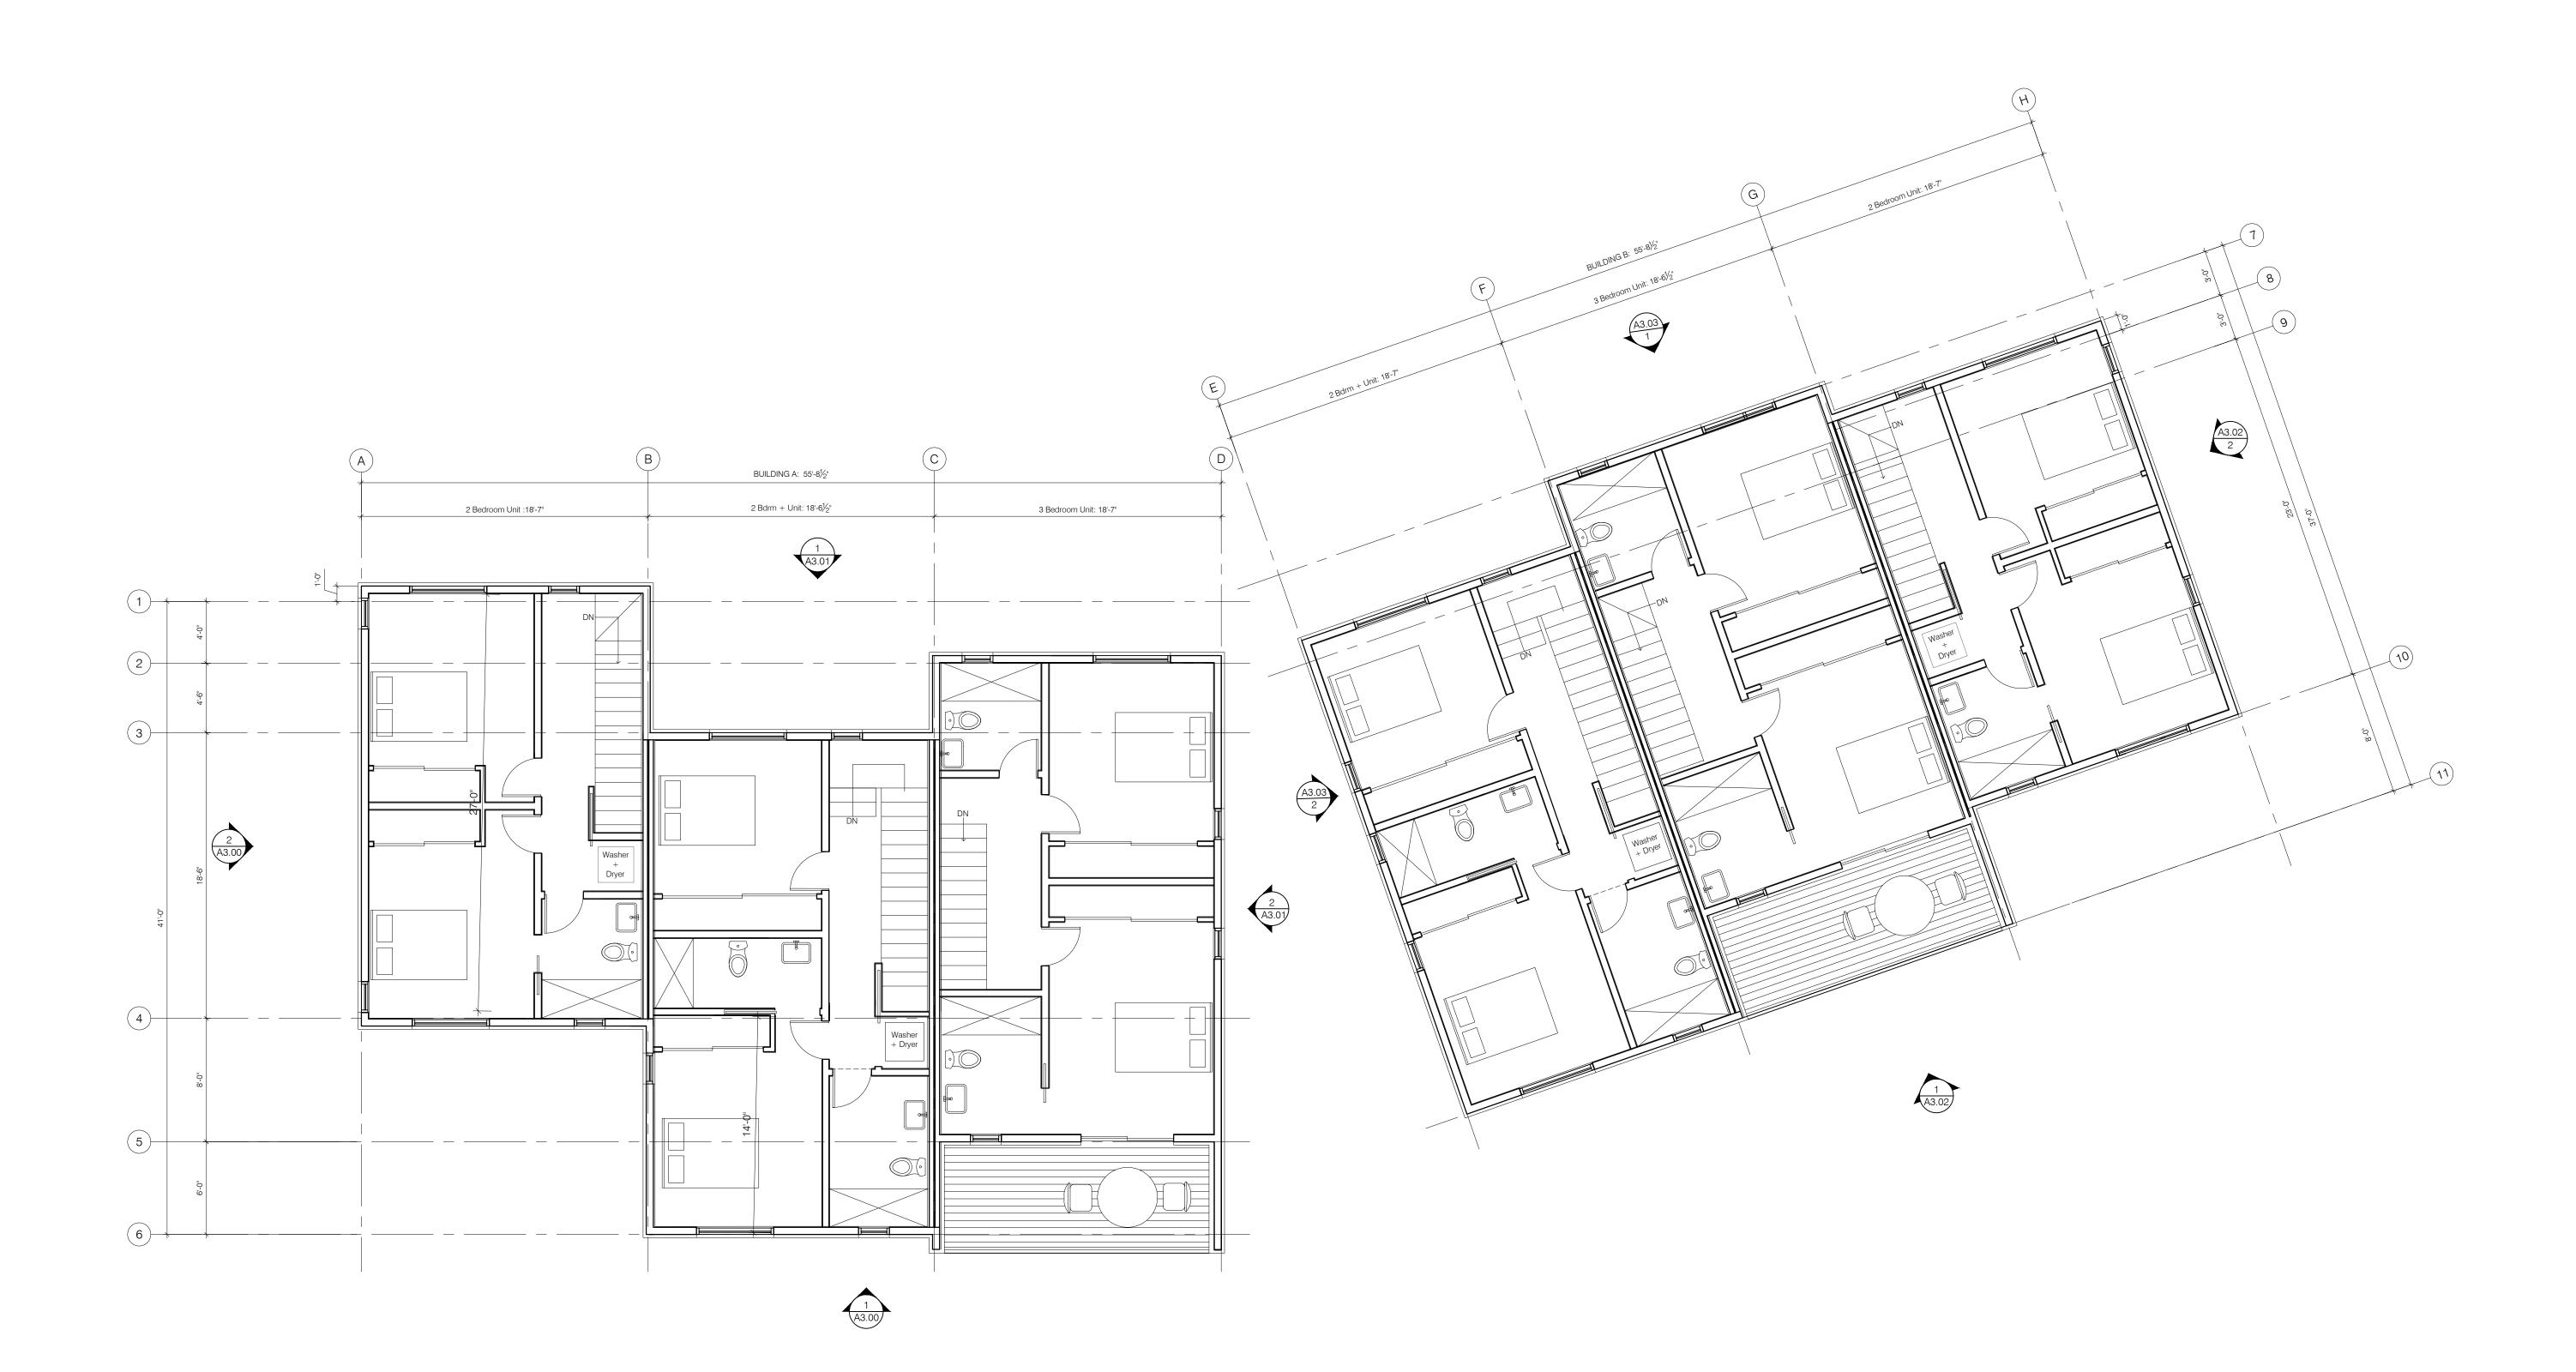
> MAGNOLIA 6-PLF 30535 SW Magnolia Avenue Wilsonville, OR 97070

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SECOND FLOOR PLAN Drawing Scale: 3/16" = 1'-0"

3ASE Job No: 19004











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Revision Date: Issue:


> MAGNOLIA 6-PLE 30535 SW Magnolia Avenue Wilsonville, OR 97070


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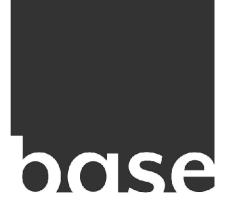


ASE Job No: 19004





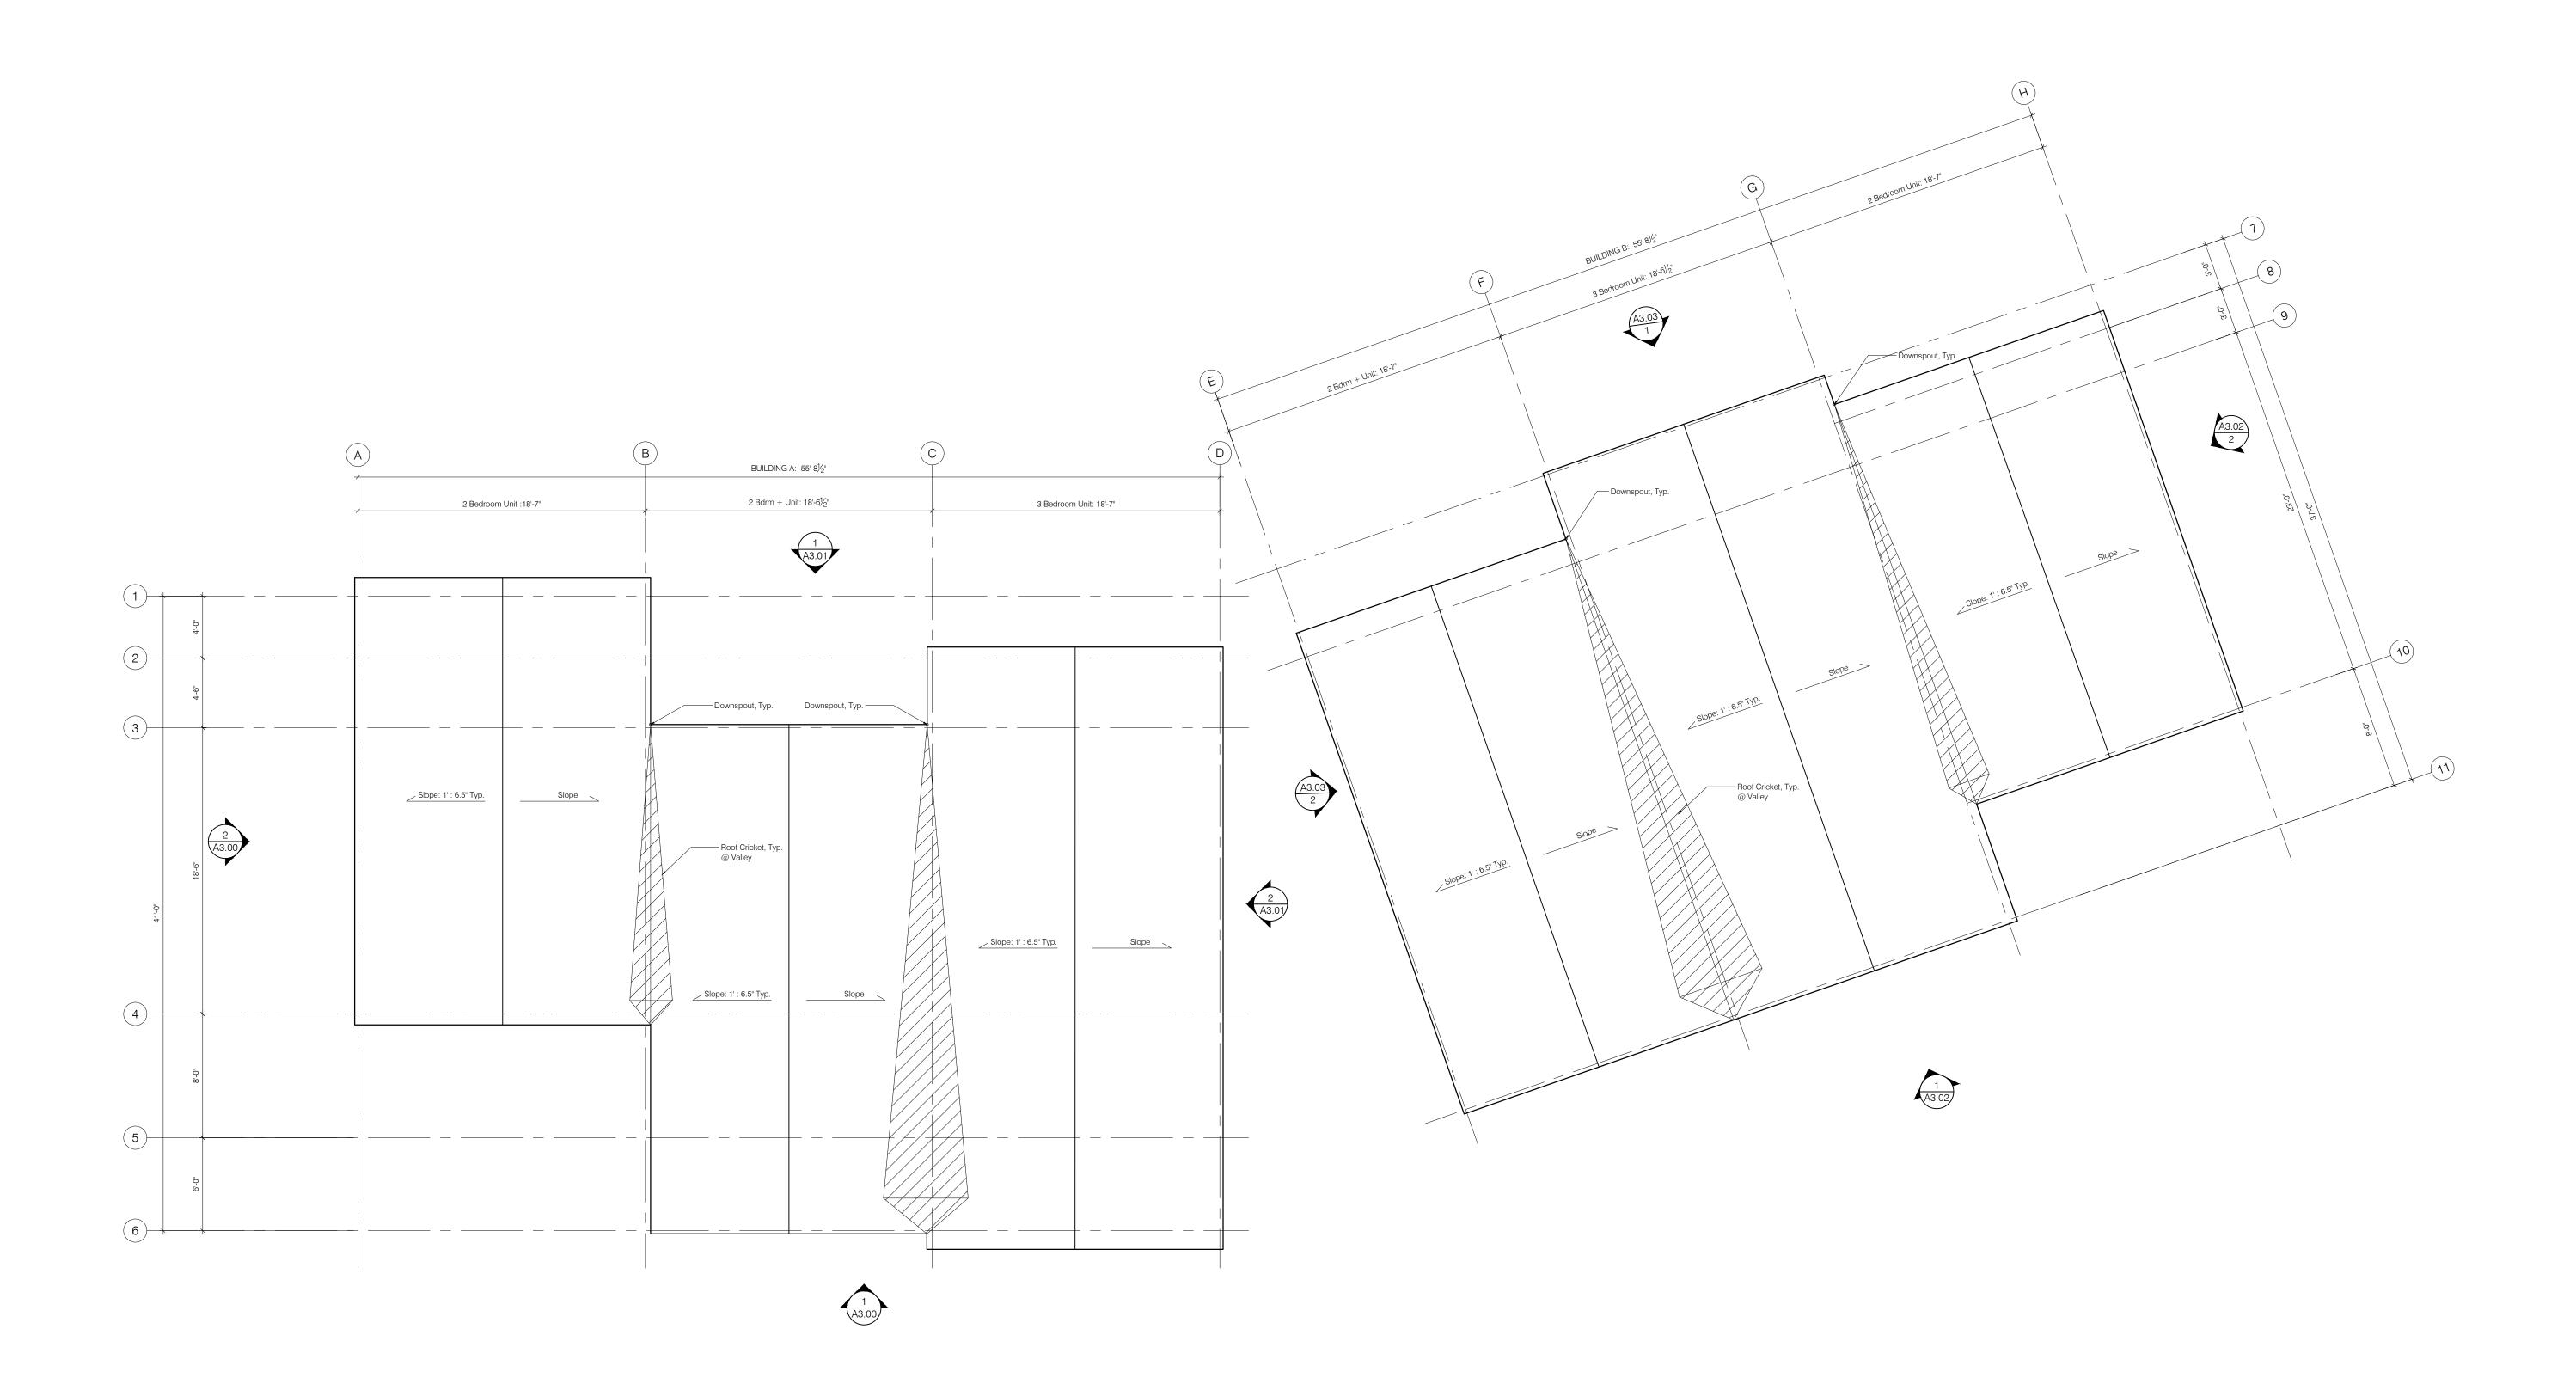

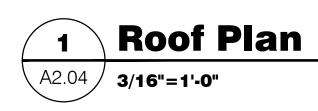


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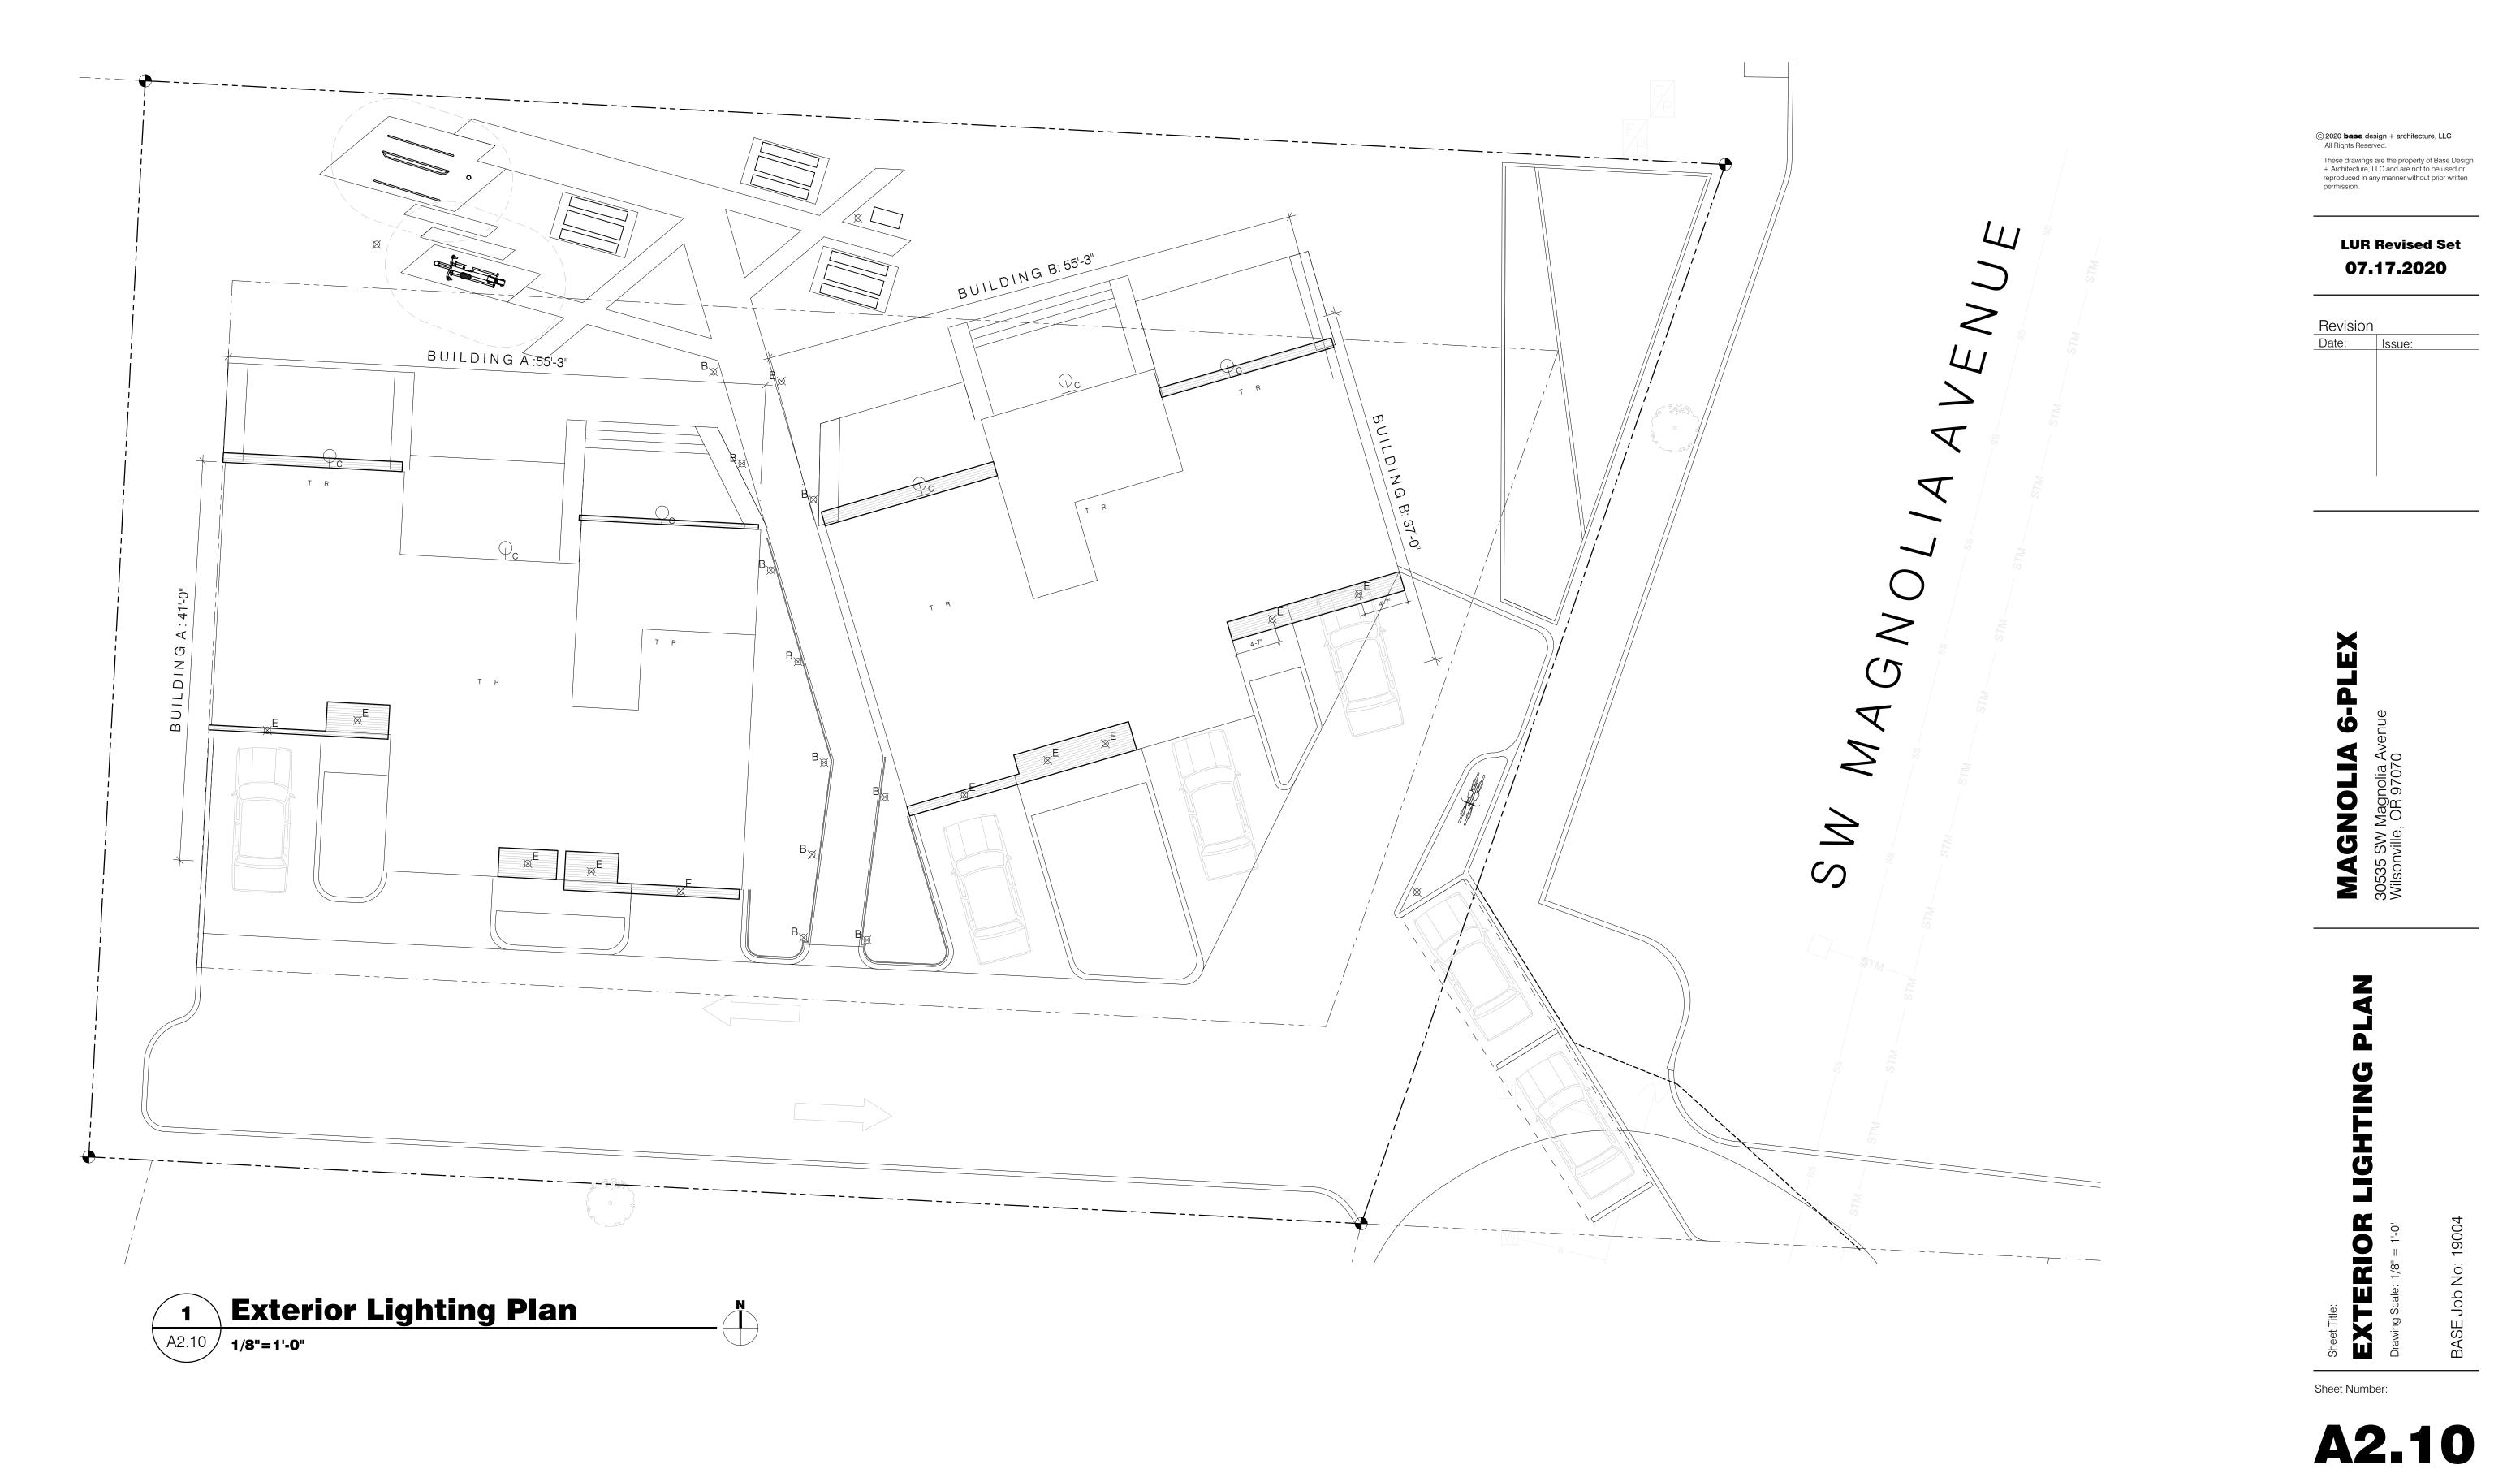
> MAGNOLIA 6-PLEX 30535 SW Magnolia Avenue Wilsonville, OR 97070



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## Legend Exterior Lighting Symbols

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 $\underline{\bigcirc}_{c}$  Surface Mount Sconce Light Fixture (Exterior Application)
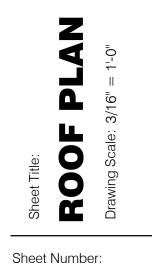
## $\otimes^{\mathsf{B}}$ Path Lights (Ballasts)

⊗^E Exterior Can Light

## Legend Ceiling Types

- T+ G Cedar Wood Panels Treated for Exterior Application

## General Notes

- All existing measurements to be verified in field. Notify Architect of any discrepancies. This includes existing light fixtures, outlets, and structural beams.
  All light fixtures to be centered on surface unless otherwise noted.




Ground Level +0'-0"




Ground Level +0'-0"

BUILDING B

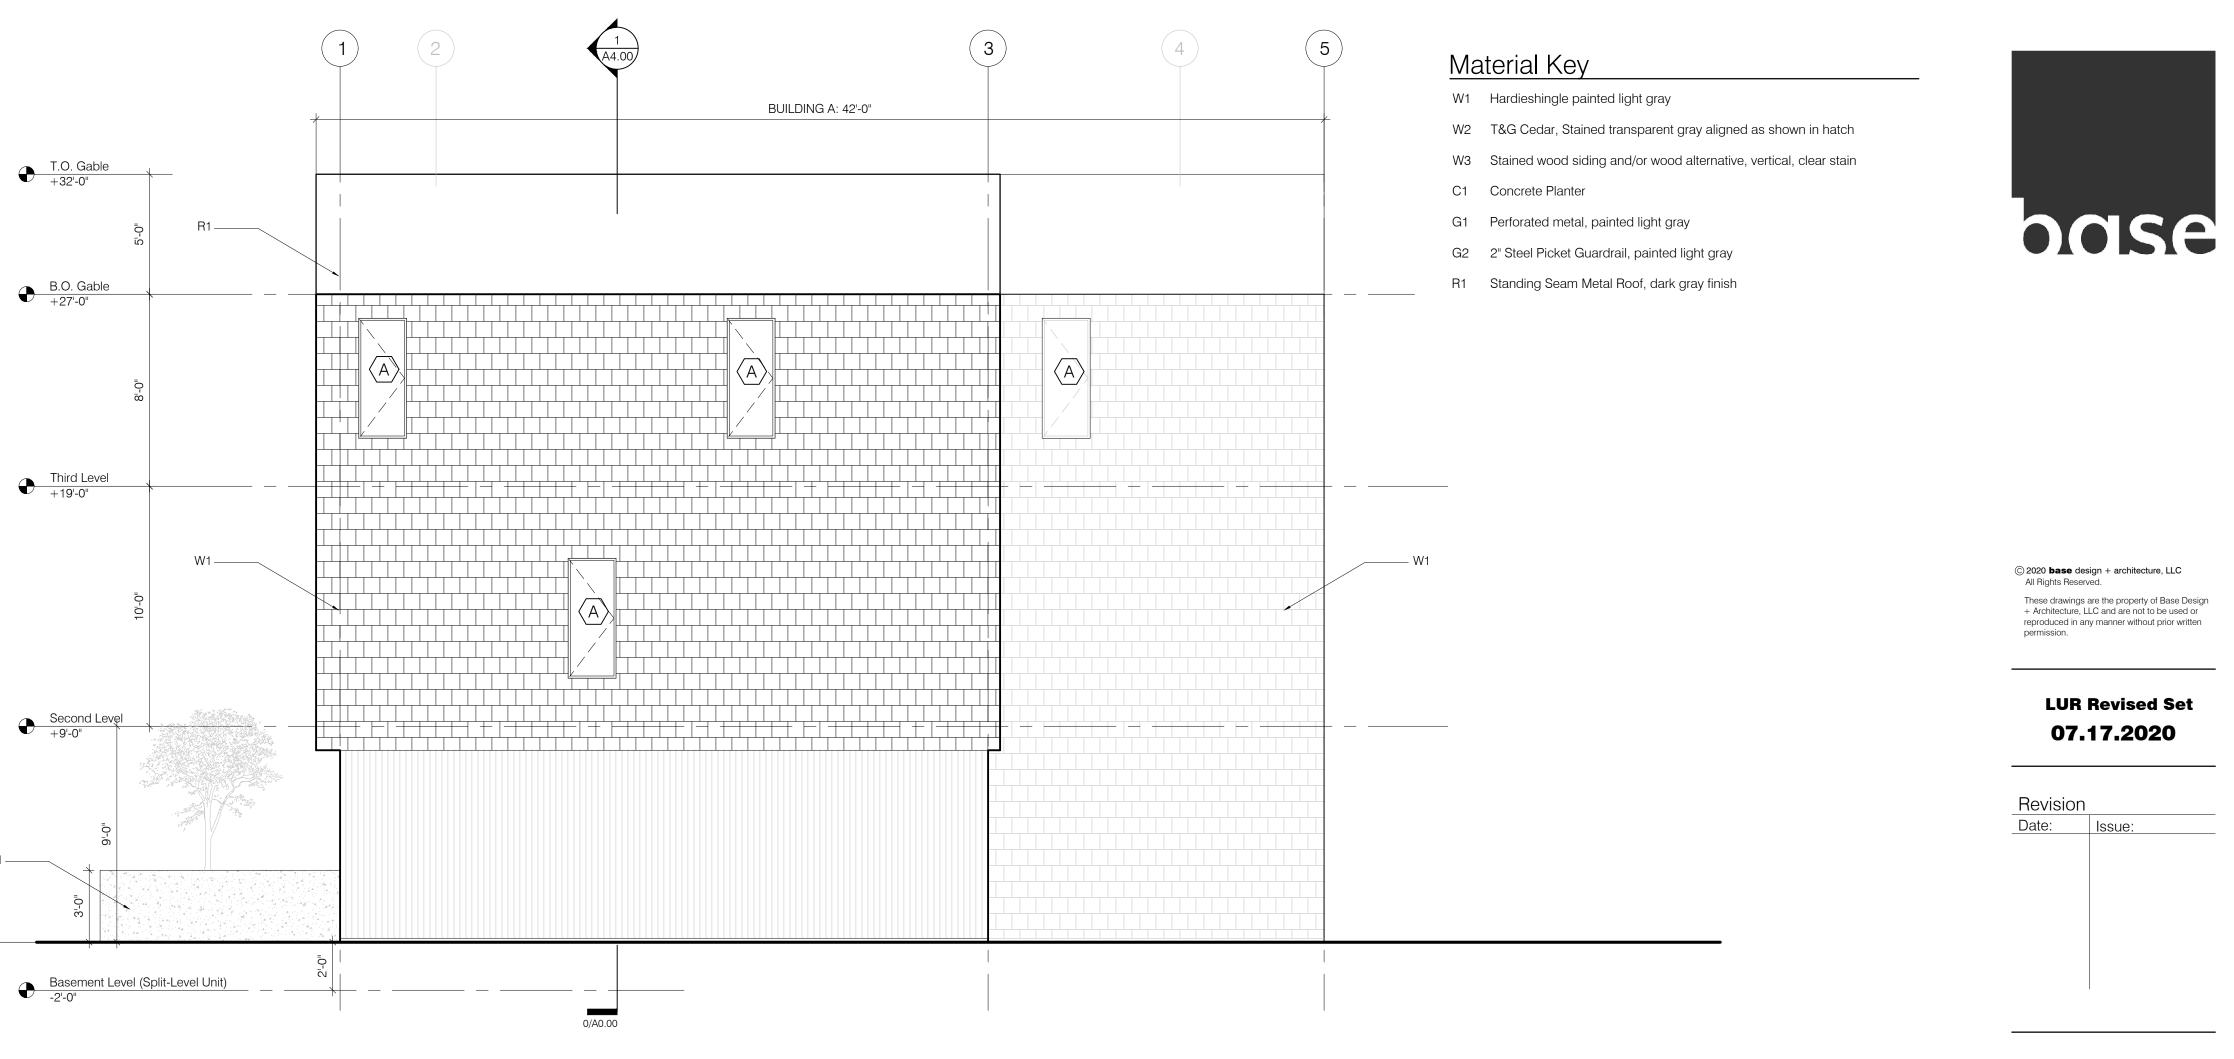



A3.01 **1/4"=1'-0**"

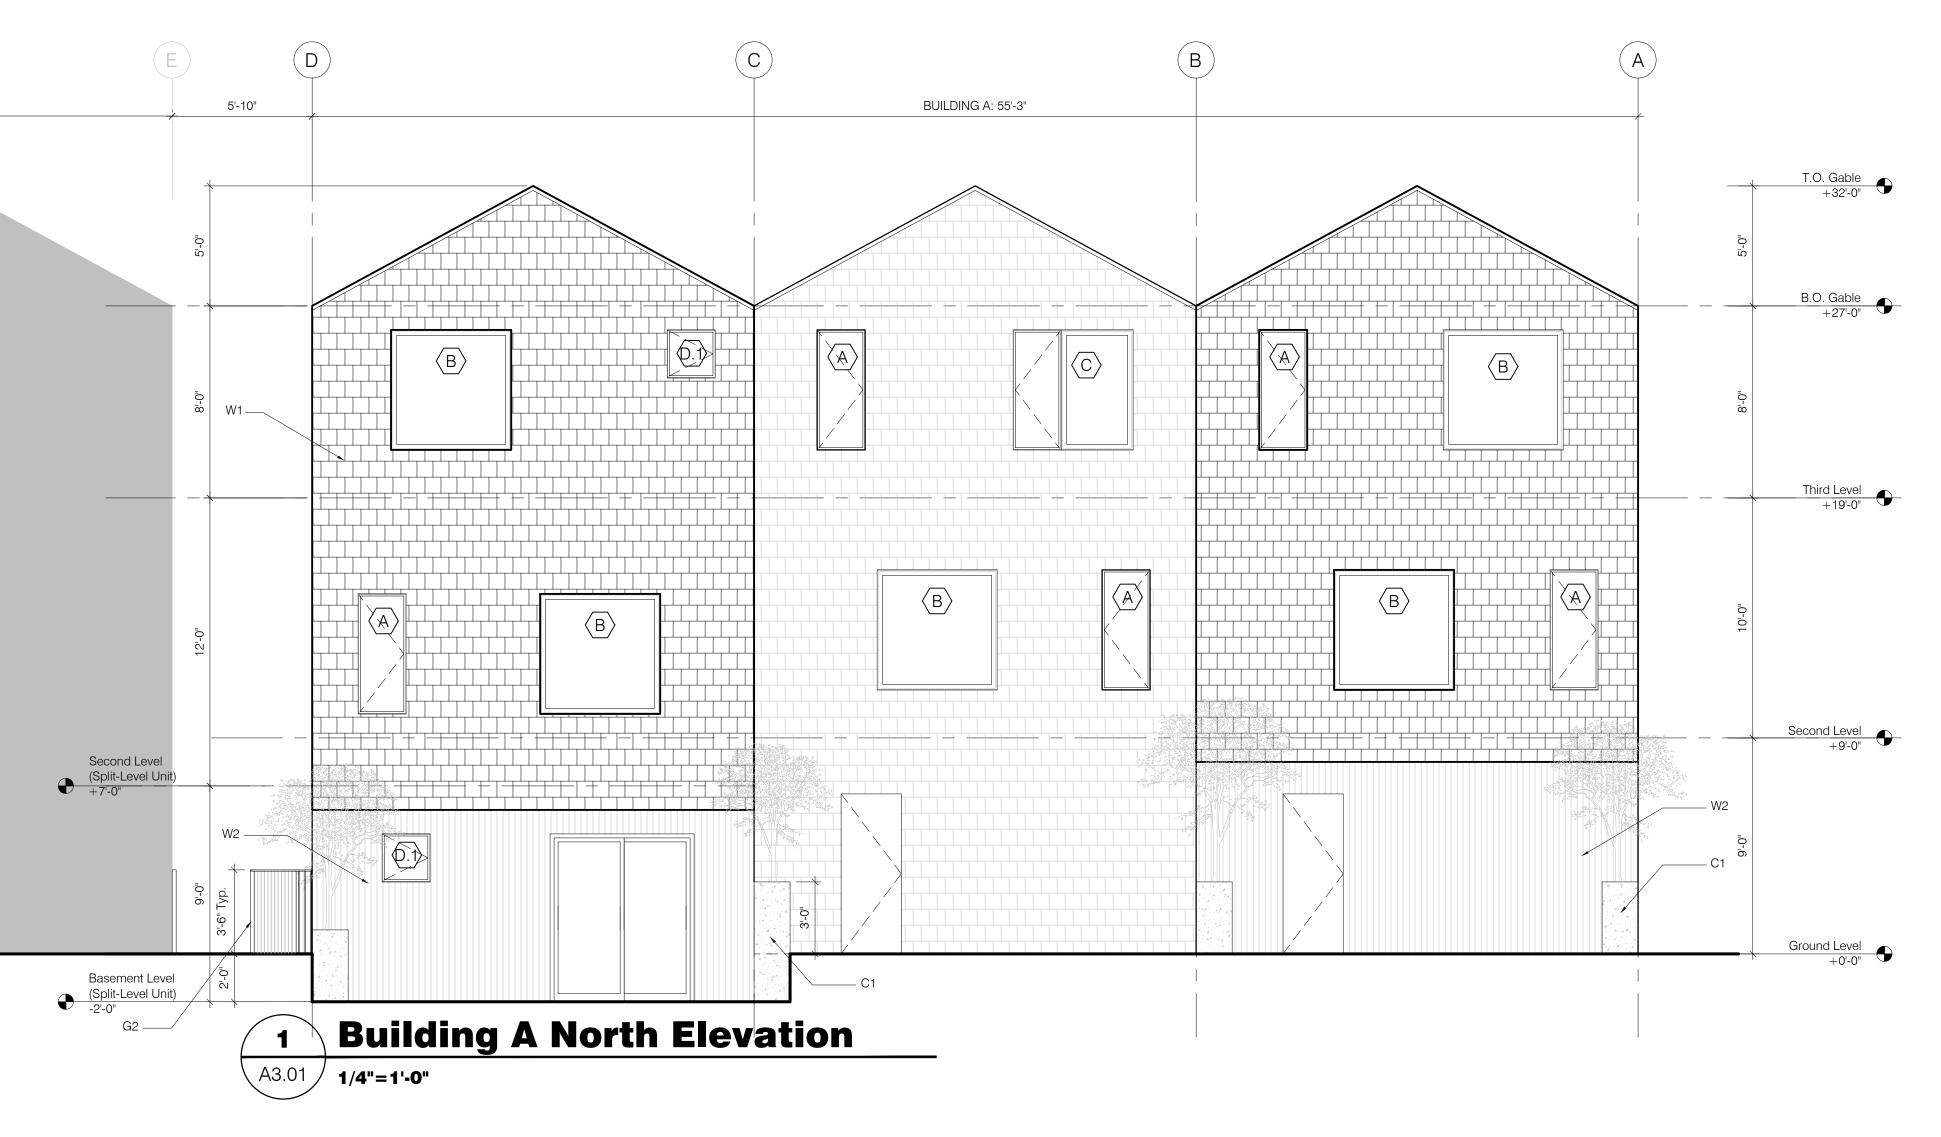

(0 MAGNOLIA 30535 SW Magnolia Aver Wilsonville, OR 97070 / Magnolia A 9, OR 97070

X

**LIONS** EXTERIOR

Sheet Number:


**A3.01** 


9004

Ground Level +0'-0"



**A3.02** 

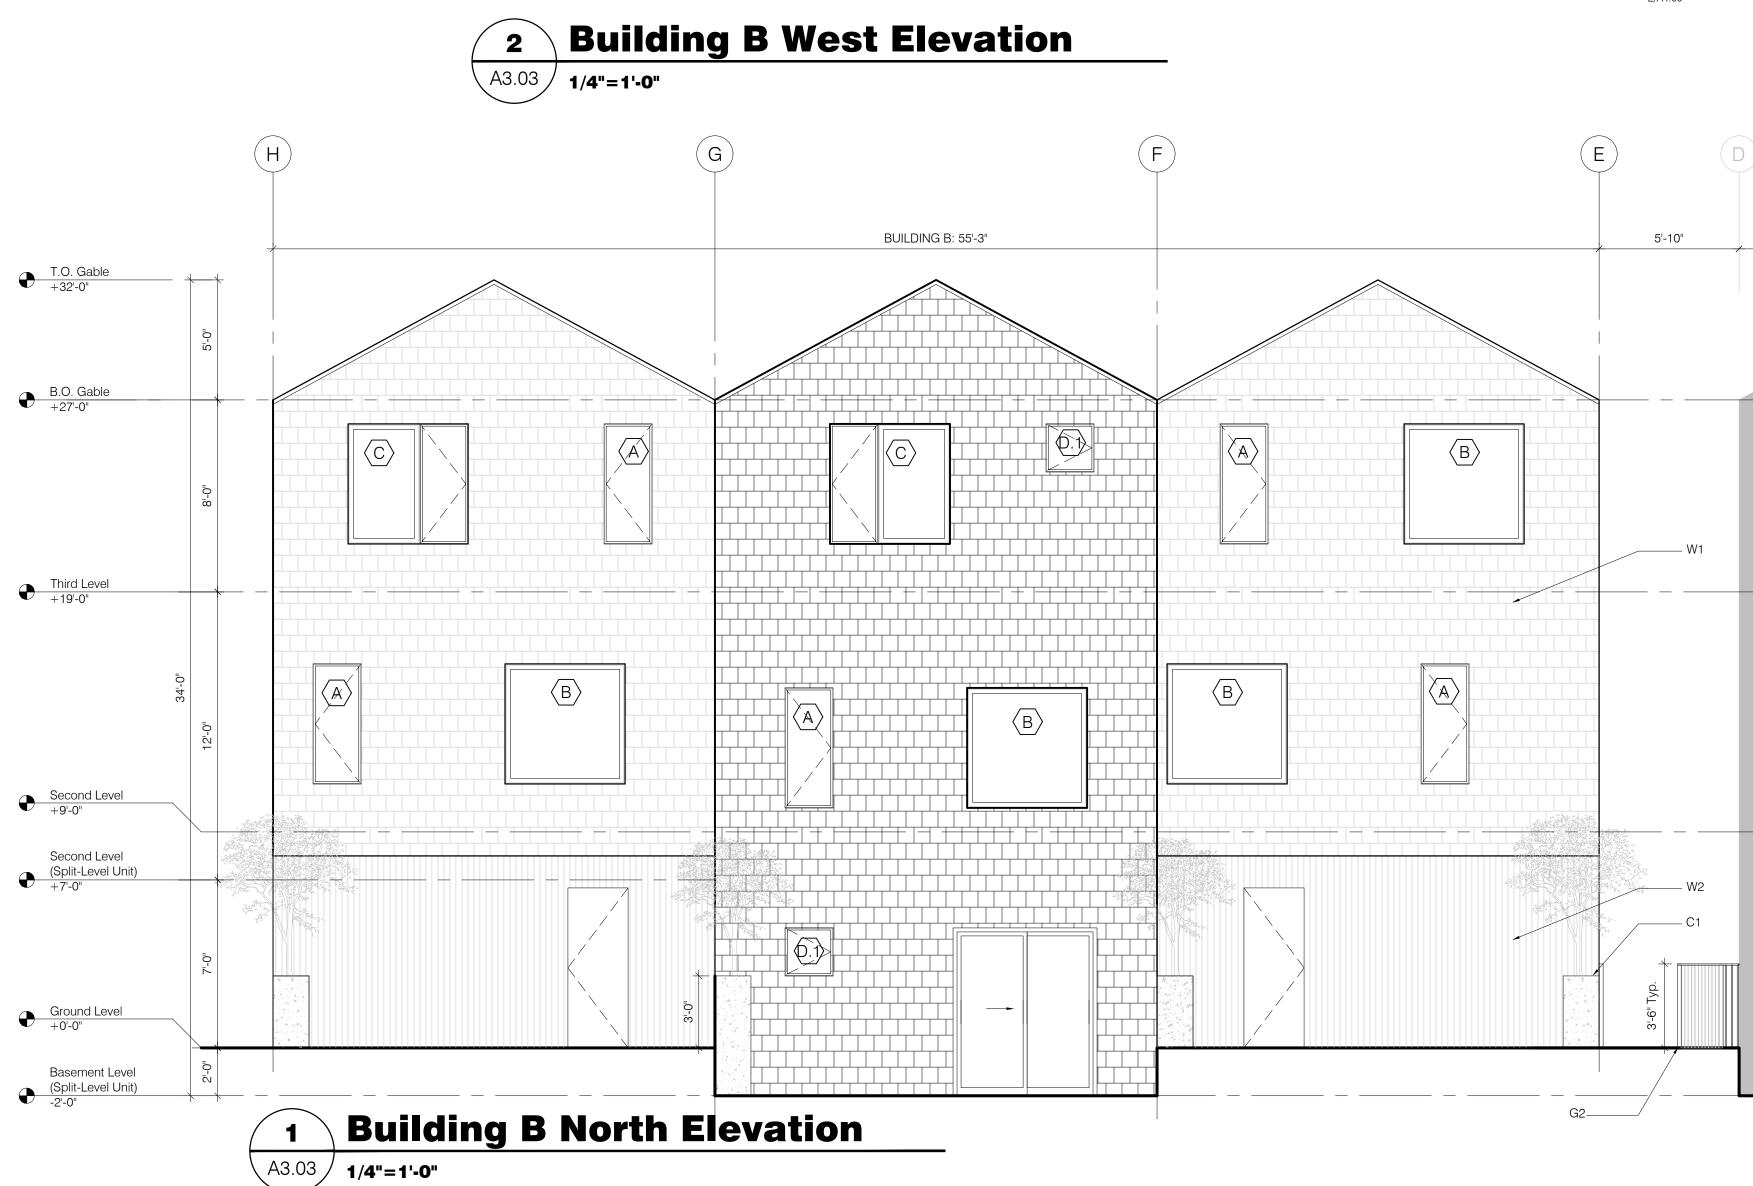

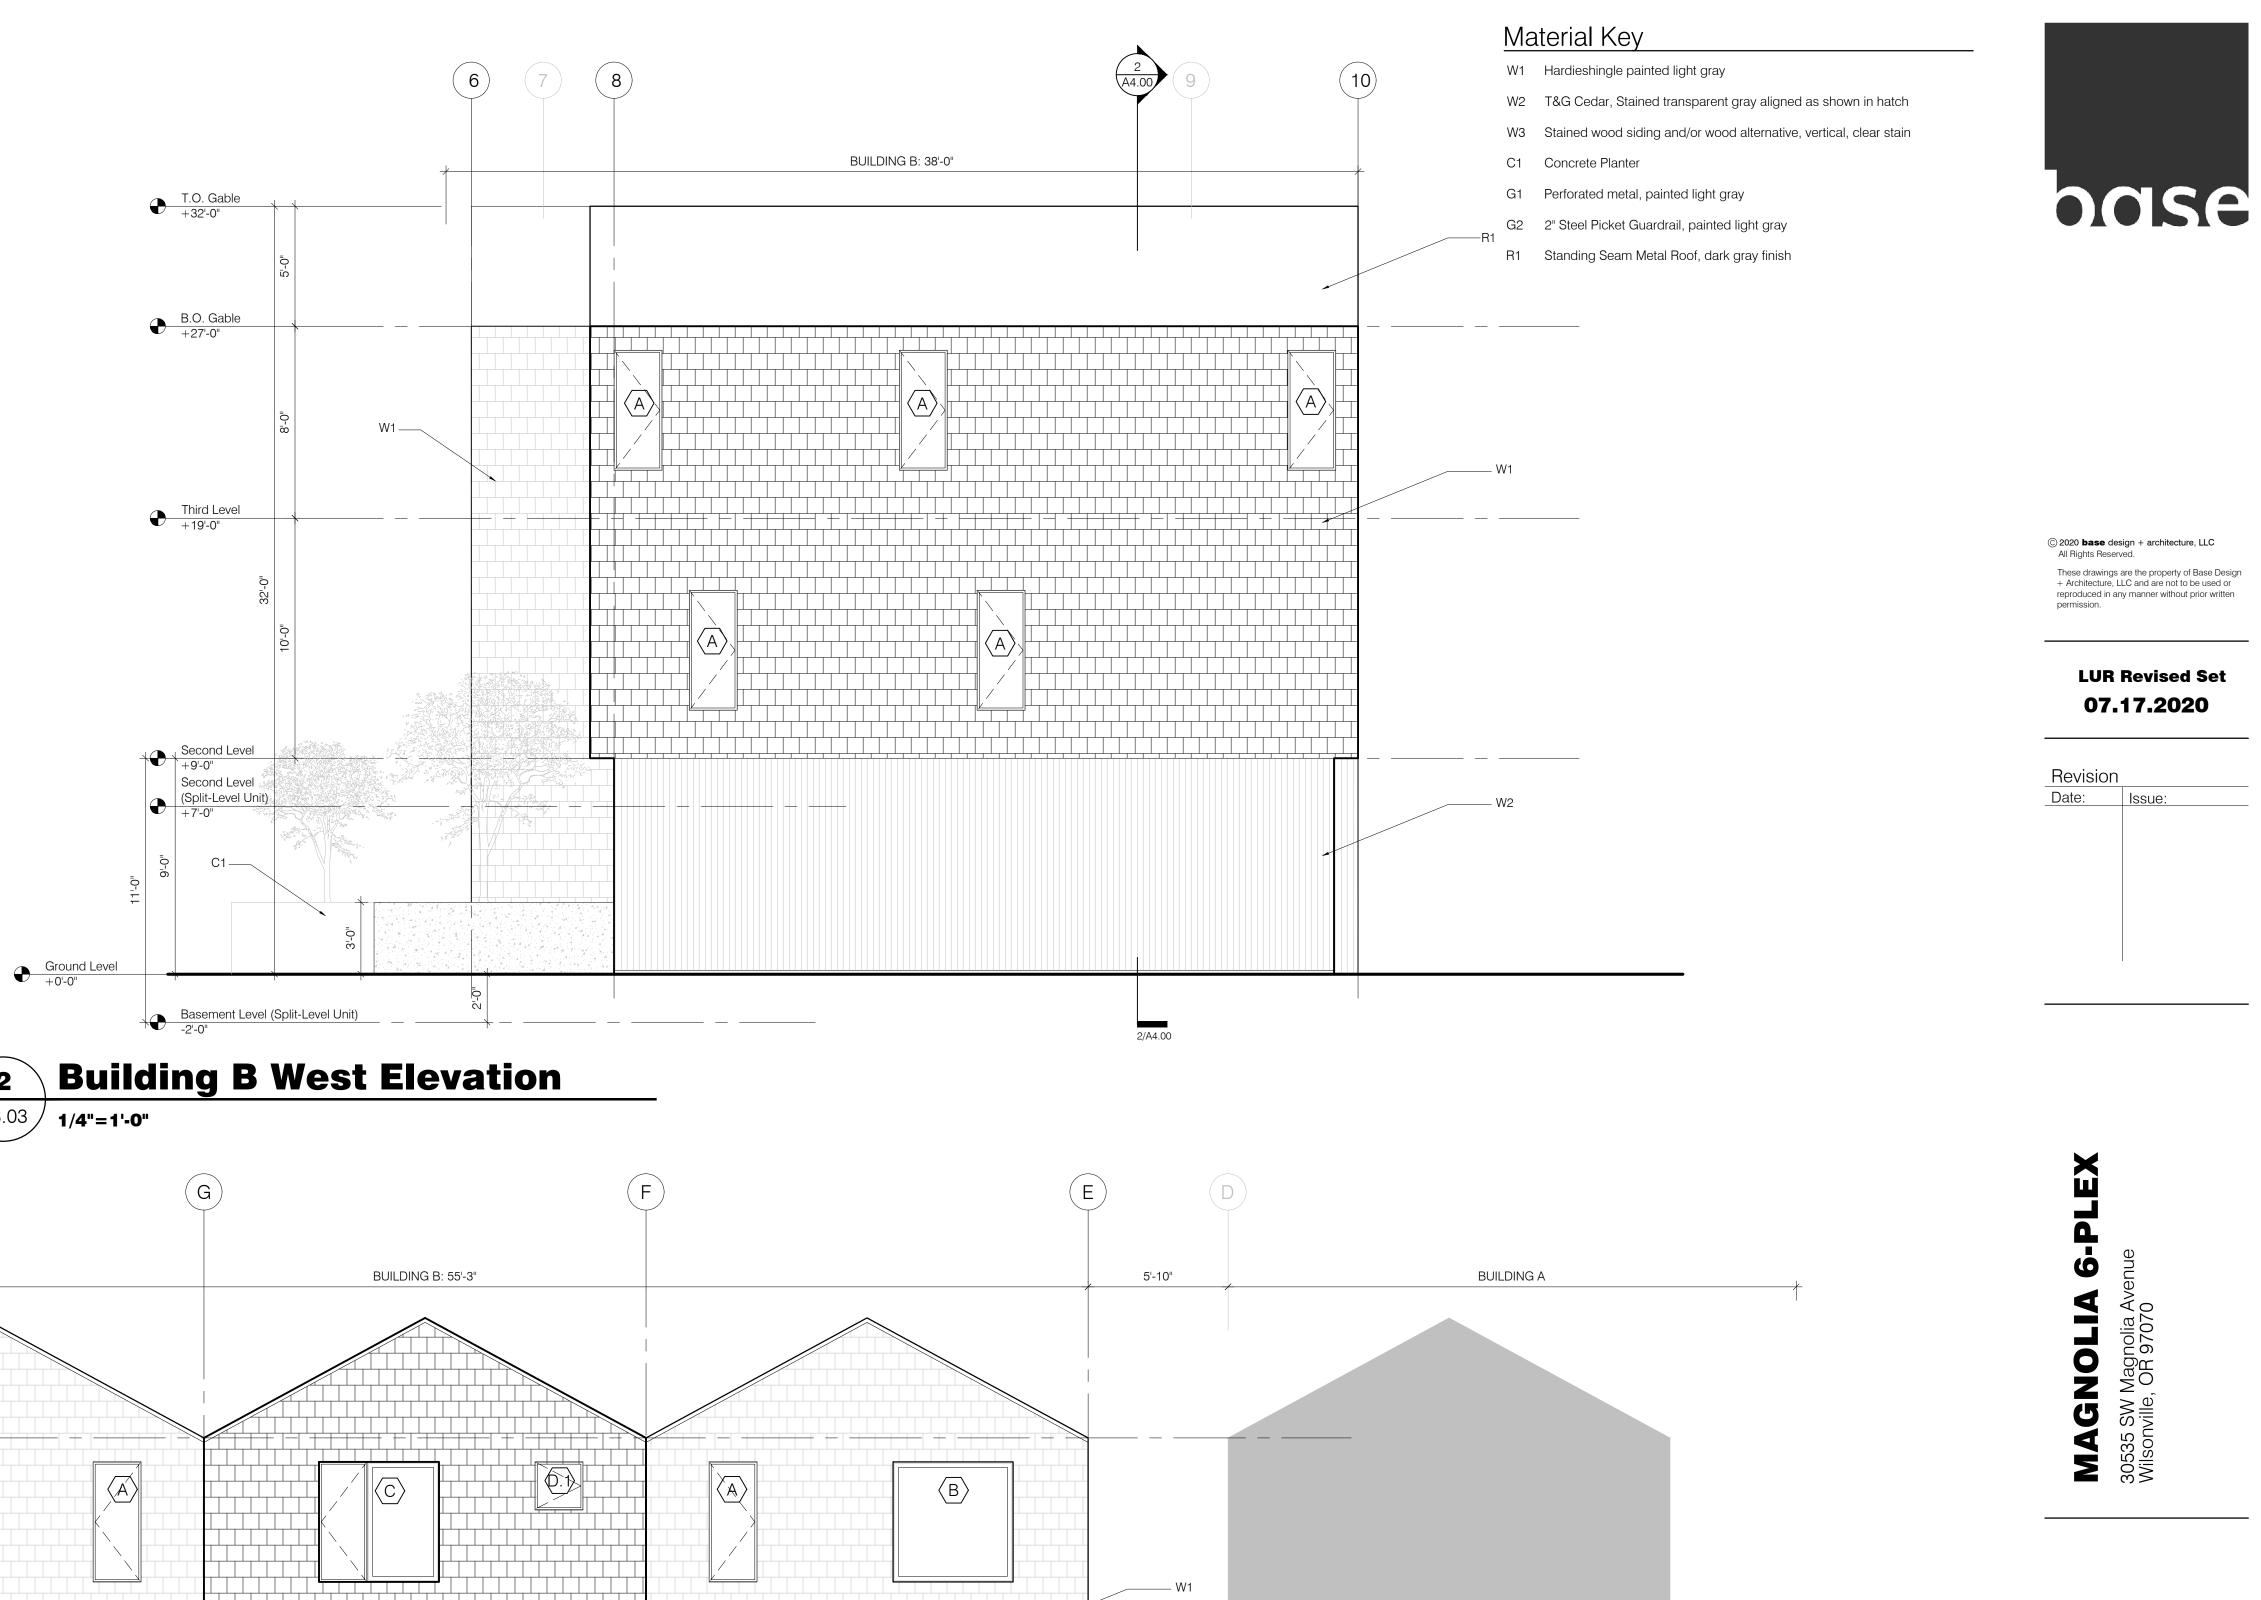


Sheet Title: **EXTERIOR ELEVATIONS** Drawing Scale: 1/4" = 1'-0"

BASE Job No: 19004





### LEGEND

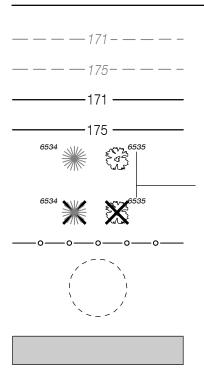

EXISTING 1' CONTOUR

EXISTING 5' CONTOUR

PROPOSED 1' CONTOUR

PROPOSED 5' CONTOUR

EXISTING TREE TO BE RETAINED TREE NUMBER

EXISTING TREE TO BE REMOVED

PROPOSED TREE PROTECTION FENCING

DRIPLINE

DRIP LINE AND ROOT PROTECTION ZONE ENCROACHMENT AREA. WORK SHALL BE SUPERVISED BY CERTIFIED ARBORIST.

### TREE PROTECTION SPECIFICATIONS


- 1. **PRECONSTRUCTION CONFERENCE.** PRIOR TO THE START OF CONSTRUCTION ACTIVITY, THE CONTRACTOR SHALL COORDINATE WITH THE PROJECT ARBORIST IN A TIMELY MANNER TO REVIEW THE TREE PROTECTION PLAN, VERIFY THAT TREES TO BE RETAINED ARE IDENTIFIED WITH NUMBERED TAGS ON THE GROUND (IF APPLICABLE), AND TO INSPECT AND VERIFY THE INSTALLATION OF TREE PROTECTION MEASURES.
- 2. **PROTECTION FENCING.** TREES TO REMAIN ON SITE SHALL BE PROTECTED BY INSTALLATION OF TREE PROTECTION FENCING AS DEPICTED ON SITE PLANS IN ORDER TO PREVENT INJURY TO TREE TRUNKS OR ROOTS, OR SOIL COMPACTION WITHIN THE ROOT PROTECTION AREA. UNLESS OTHERWISE APPROVED BY THE CITY, FENCES SHALL BE A MINIMUM 6-FOOT HIGH 2-INCH CHAIN LINK MESH SECURED TO METAL POSTS DRIVEN INTO THE GROUND.

ALONG THE NORTHERN AND EASTERN PROPERTY BOUNDARIES, EXISTING PROPERTY BOUNDARY FENCES ARE DESIGNATED AS TREE PROTECTION; IF ANY EXISTING FENCES ACTING AS TREE PROTECTION FENCING ARE REMOVED DURING CONSTRUCTION, TREE PROTECTION FENCING SHALL BE INSTALLED IMMEDIATELY UNLESS OTHER ARRANGEMENTS ARE COORDINATED WITH AND DOCUMENTED BY THE PROJECT ARBORIST. THE CONTRACTOR IS RESPONSIBLE FOR COORDINATING WITH THE PROJECT ARBORIST IN A TIMELY MANNER PRIOR TO OPENING, ADJUSTING OR REMOVING TREE PROTECTION FENCING.

- 3. TREE PROTECTION ZONE. WITHOUT AUTHORIZATION FROM THE PROJECT ARBORIST, NONE OF THE FOLLOWING SHALL OCCUR BENEATH THE DRIPLINE OF ANY PROTECTED TREE:
  - a) GRADE CHANGE OR CUT AND FILL;
  - b) NEW IMPERVIOUS SURFACES;
  - c) UTILITY OR DRAINAGE FIELD PLACEMENT;
  - d) STAGING OR STORAGE OF MATERIALS AND EQUIPMENT; OR
  - e) VEHICLE MANEUVERING.

THE CONTRACTOR SHALL BE RESPONSIBLE FOR CONTACTING THE PROJECT ARBORIST IN A TIMELY MANNER PRIOR TO WORKING BENEATH PROTECTED TREE DRIPLINES. ROOT PROTECTION ZONES MAY BE ENTERED FOR TASKS LIKE SURVEYING, MEASURING AND SAMPLING. FENCES MUST BE CLOSED UPON COMPLETION OF THESE TASKS.

- 4. TREE AND STUMP REMOVAL. PROTECTION FENCING AT TREE #7001 MAY BE TEMPORARILY OPENED FOR REMOVAL OF TREES #6092-6096. TREE REMOVAL SHALL BE PERFORMED WITH HAND TOOLS ONLY AND TREES SHALL BE DIRECTIONALLY FELLED TO AVOID DAMAGE TO REMAINING NEARBY TREES. THE STUMPS OF TREES #6092-6096 SHALL BE REMOVED APPROXIMATELY 6-INCHES BELOW THE GROUND SURFACE USING A STUMP GRINDER OR ELSE EXTRACTED FROM THE GROUND UNDER THE PROJECT ARBORIST'S DIRECTION AND OVERSIGHT.
- 5. **PRUNING.** PRUNING MAY BE NEEDED TO PROVIDE OVERHEAD CLEARANCE AND TO REMOVE DEAD AND DEFECTIVE BRANCHES FOR SAFETY. THE PROJECT ARBORIST CAN HELP IDENTIFY WHERE PRUNING IS NECESSARY ONCE TREES RECOMMENDED FOR REMOVAL HAVE BEEN REMOVED AND THE SITE IS PREPARED FOR CONSTRUCTION. TREE REMOVAL AND PRUNING SHALL BE PERFORMED BY A QUALIFIED TREE SERVICE.
- 6. CURB AND UTILITY TRENCH EXCAVATION. EXCAVATION WITHIN THE DRIPLINE ENCROACHMENT AREA OF PROTECTED TREES SHALL BE PERFORMED UNDER ARBORIST SUPERVISION. AN EXCAVATOR WITH A FLAT-BLADE BUCKET MAY BE USED TO SLOWLY REMOVE SOIL IN SHALLOW LAYERS TO THE NECESSARY DEPTH. IF TREE ROOTS ARE ENCOUNTERED, STOP MACHINE-DIGGING AND HAND-DIG TO EVALUATE ROOT SIZE; THE PROJECT ARBORIST MAY REQUIRE ALTERNATIVE MEANS OF EXCAVATION SUCH AS AIR-SPADING OR HYDRO-VACUUM EXCAVATION IN ORDER TO MINIMIZE ROOT IMPACTS, IF NEEDED. EXPOSED ROOTS SMALLER THAN 2-INCHES IN DIAMETER SHALL BE PRUNED CLEAN TO SOUND WOOD WITH A SHARP SAW OR PRUNING SHEARS AT THE LIMITS OF EXCAVATION AS DIGGING PROGRESSES IN ORDER TO AVOID PULLING AND TEARING ROOTS AND MINIMIZE POTENTIAL IMPACTS. ROOTS 2-INCHES AND LARGER IN DIAMETER SHALL BE ASSESSED AND DOCUMENTED BY THE PROJECT ARBORIST. WHERE FEASIBLE, MAJOR ROOTS SHALL BE PROTECTED BY TUNNELING OR OTHER MEANS TO AVOID DESTRUCTION OR DAMAGE. EXCEPTIONS CAN BE MADE IF, IN THE OPINION OF THE PROJECT ARBORIST, UNACCEPTABLE DAMAGE WILL NOT OCCUR TO THE TREE. THE CONTRACTOR IS RESPONSIBLE FOR COORDINATING WITH THE PROJECT ARBORIST IN A TIMELY MANNER PRIOR TO IMPACTING ROOTS OF PROTECTED TREES.
- 7. QUALITY ASSURANCE. A QUALIFIED ARBORIST SHOULD SUPERVISE PROPER EXECUTION OF THIS PLAN ON-CALL DURING CONSTRUCTION ACTIVITIES THAT COULD ENCROACH ON RETAINED TREES. TREE PROTECTION SITE INSPECTION MONITORING REPORTS SHOULD BE PROVIDED TO THE CLIENT AND CITY FOLLOWING EACH SITE VISIT PERFORMED DURING CONSTRUCTION.

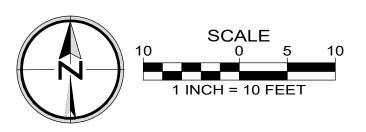



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> MAGNOLIA 6-PLE 30535 SV Magnolia Avenue Wilsonville, OR 97070



BASE Job No: 7




No.	Туре	Common Name	Species Name	DBH1	C-Rad2	Cond3	Comments	Location	Treatment
6011	Dec	Japanese maple	Acer palmatum	5	4	F	May be neighbor's transplant	On-site	Remove
6092	Dec	black locust	Robinia pseudoacacia	11	18	F	Invasive species, high live crown	On-site	Remove
6093	Dec	black locust	Robinia pseudoacacia	6	11	F	Invasive species, small live crown, poor structure	On-site	Remove
6094	Dec	black locust	Robinia pseudoacacia	10	20	F	Invasive species, high live crown	On-site	Remove
6095	Dec	black locust	, Robinia pseudoacacia	9	20	F	Invasive species, one-sided crown to S	On-site	Remove
6096	Dec	black locust	Robinia pseudoacacia	11	20	F	Invasive species, high live crown	On-site	Remove
6097	Dec	black locust	Robinia pseudoacacia	10	22	F	Invasive species, one-sided crown to S, trunk wound E face	On-site	Remove
6098	Dec	black locust	Robinia pseudoacacia	10	20	F	Invasive species, dead and broken branches, high live crown	On-site	Remove
6099	Dec	black locust	Robinia pseudoacacia	17	20	F	Invasive species, codominant stems with included bark, lower trunk wound N face	On-site	Remove
6100	Dec	silver maple	Acer saccharinum	*19	25	F	Crown mostly one-sided to S, limited visual assessment	Off-site	Protect
6101	Dec	black locust	Robinia pseudoacacia	31	24	F	Invasive species, multiple stems, dead and broken branches	On-site	Remove
6126	Dec	Norway maple	Acer platanoides	28	28	G	Invasive species, few dead and broken branches, broad crown, bacterial wet wood in codominant leader attachment on N face	On-site	Remove
6142	Dec	elm	Ulmus spp.	18,26	30	Р	Very poor structure, history of branch failure, dead and broken branches, trunk and crown decay	On-site	Remove
6194	Con	lodgepole pine	Pinus contorta	19	18	F	Codominant leaders, heavily infested with sequoia pitch moth	Off-site	*Remove
6195	Dec	sweetgum	Liquidambar styraciflua	10	14	G	Lower trunk wound	Off-site	*Remove
6196	Dec	sweetgum	Liquidambar styraciflua	13	12	G	Crown is somewhat one-sided to E	Off-site	Protect
7001	Dec	deciduous	unknown	*24	22	G	Moderate structure, limited visual assessment	Off-site	Protect
7002	Con	deodar cedar	Cedrus deodara	*9	15	G	Limited visual assessment	Off-site	Protect
vas limite	d by site a		s were visually appro			es. Asteri	isk (*) indentifies off-site trees v	where asse	ssment

y for Magnolia 6-Plex	
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**Cond** is an arborist assigned rating to generally describe the condition of the individual trees as **D**ead, **P**oor, **F**air, **G**ood, or **E**xcellent *Removal of off-site trees requires prior written consent of adjacent property owner.

This Detail Drawing may not be altered o	r change
DRIP LINE	
	îx
6'	
6	
NOTES: 1. FENCE SHALL BE 6' IN HEIGH	
2. FENCE MATERIALS SHALL CO MINIMUM 1 1/2" DIA. STEEL 3. POSTS SHALL BE SET TO A DE	OR ALUI
4. FENCE SHALL REMAIN IN PLA REMOVAL OF FENCE REQUIRE	CE UNT
Tree Pro	tectio
RAWING NUMBER: RD-1230	DR
LE NAME: RD-1230.DWG	APPI

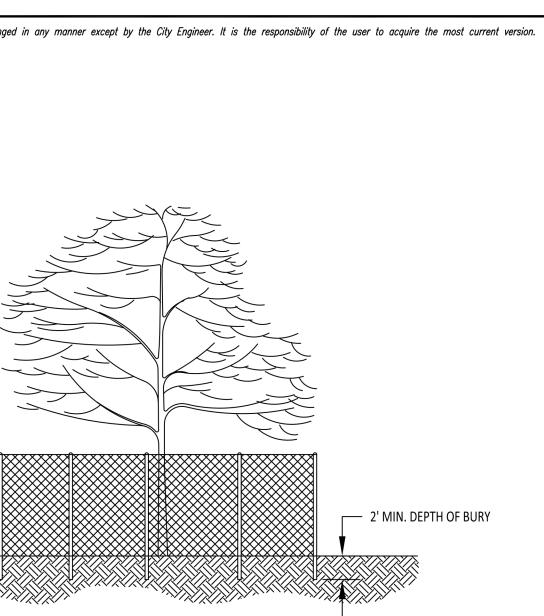

- D SET AT TREE DRIP LINE. T OF 2" MESH CHAIN LINKS SECURED TO A
- UMINUM LINE POSTS.
- OF NO LESS THAN 2 FEET IN NATIVE SOIL. NTIL THE COMPLETION OF CONSTRUCTION ACTIVITIES. MOVEMENT OR PROVAL BY CITY'S AUTHORIZED REPRESENTATIVE.

ion Fencing		CITY OF	
RAWN BY: SR	SCALE: N.T.S.	WILSONVILLE	
PROVED BY: NK	DATE: 4/2/14	PUBLIC WORKS ST	ANDARDS



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SW Magnolia Av wille, OR 97070 ອ ≥



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Sheet Number:


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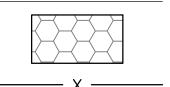
PORTLAND, OREGON 97223 P 503.643.8286 www.pd-grp.com








## LEGEND

151
— — — — 155 — — — —
151
155

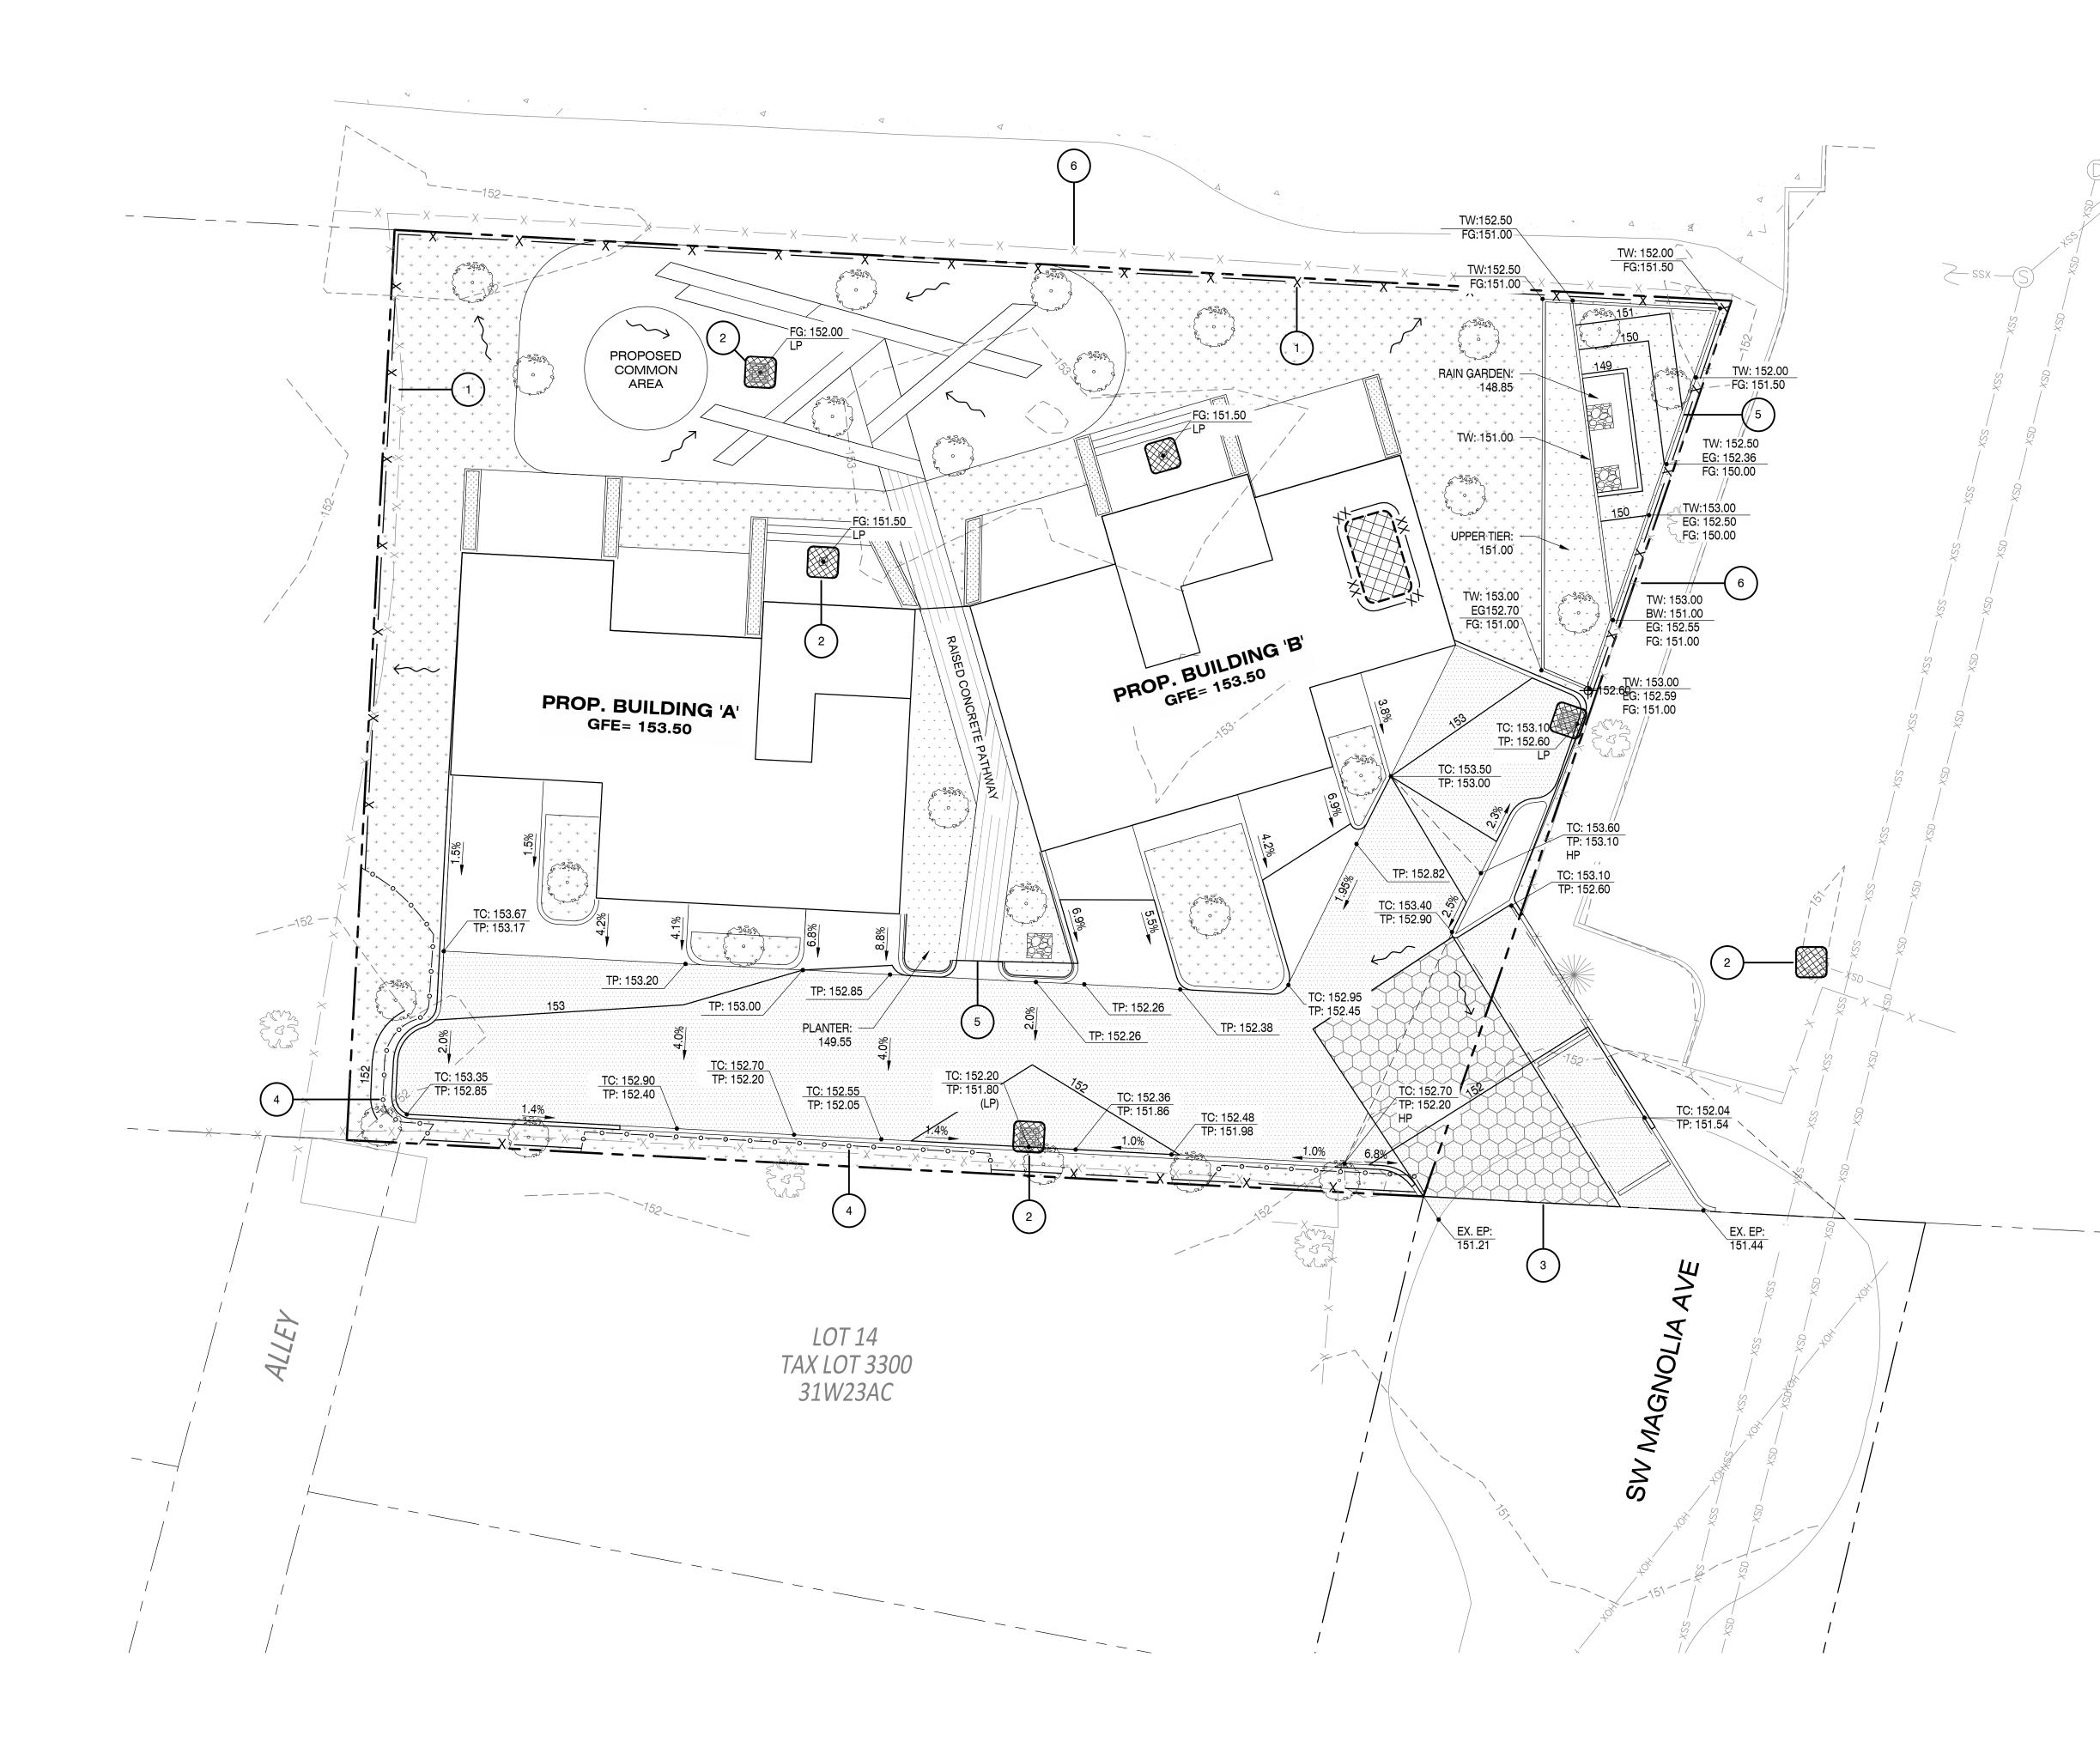

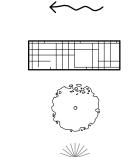

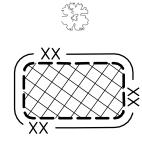

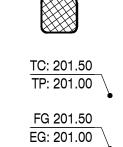

PROPOSED LANDSCAPE TREE EXISTING CONIFEROUS TREE EXISTING DECIDUOUS TREE

EXISTING 1' CONTOUR

EXISTING 5' CONTOUR PROPOSED 1' CONTOUR PROPOSED 5' CONTOUR

PROPOSED RETAINING WALL

PROPOSED FLOW LINE

PROPOSED LIDA FACILITY

PROPOSED CONSTRUCTION ENTRANCE

PROPOSED EROSION CONTROL FENCING

PROPOSED STOCKPILE LOCATION

PROPOSED TYPE 5 INLET PROTECTION

TC = TOP OF CURB ELEVATION

TP = TOP OF PAVEMENT ELEVATION

FG = FINISH GRADE ELEVATION EG = EXISTING GROUND ELEVATION



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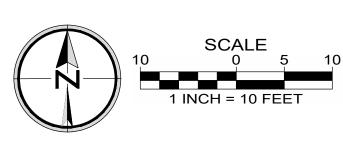
RevisionDate:Issue:

## GRADING NOTES















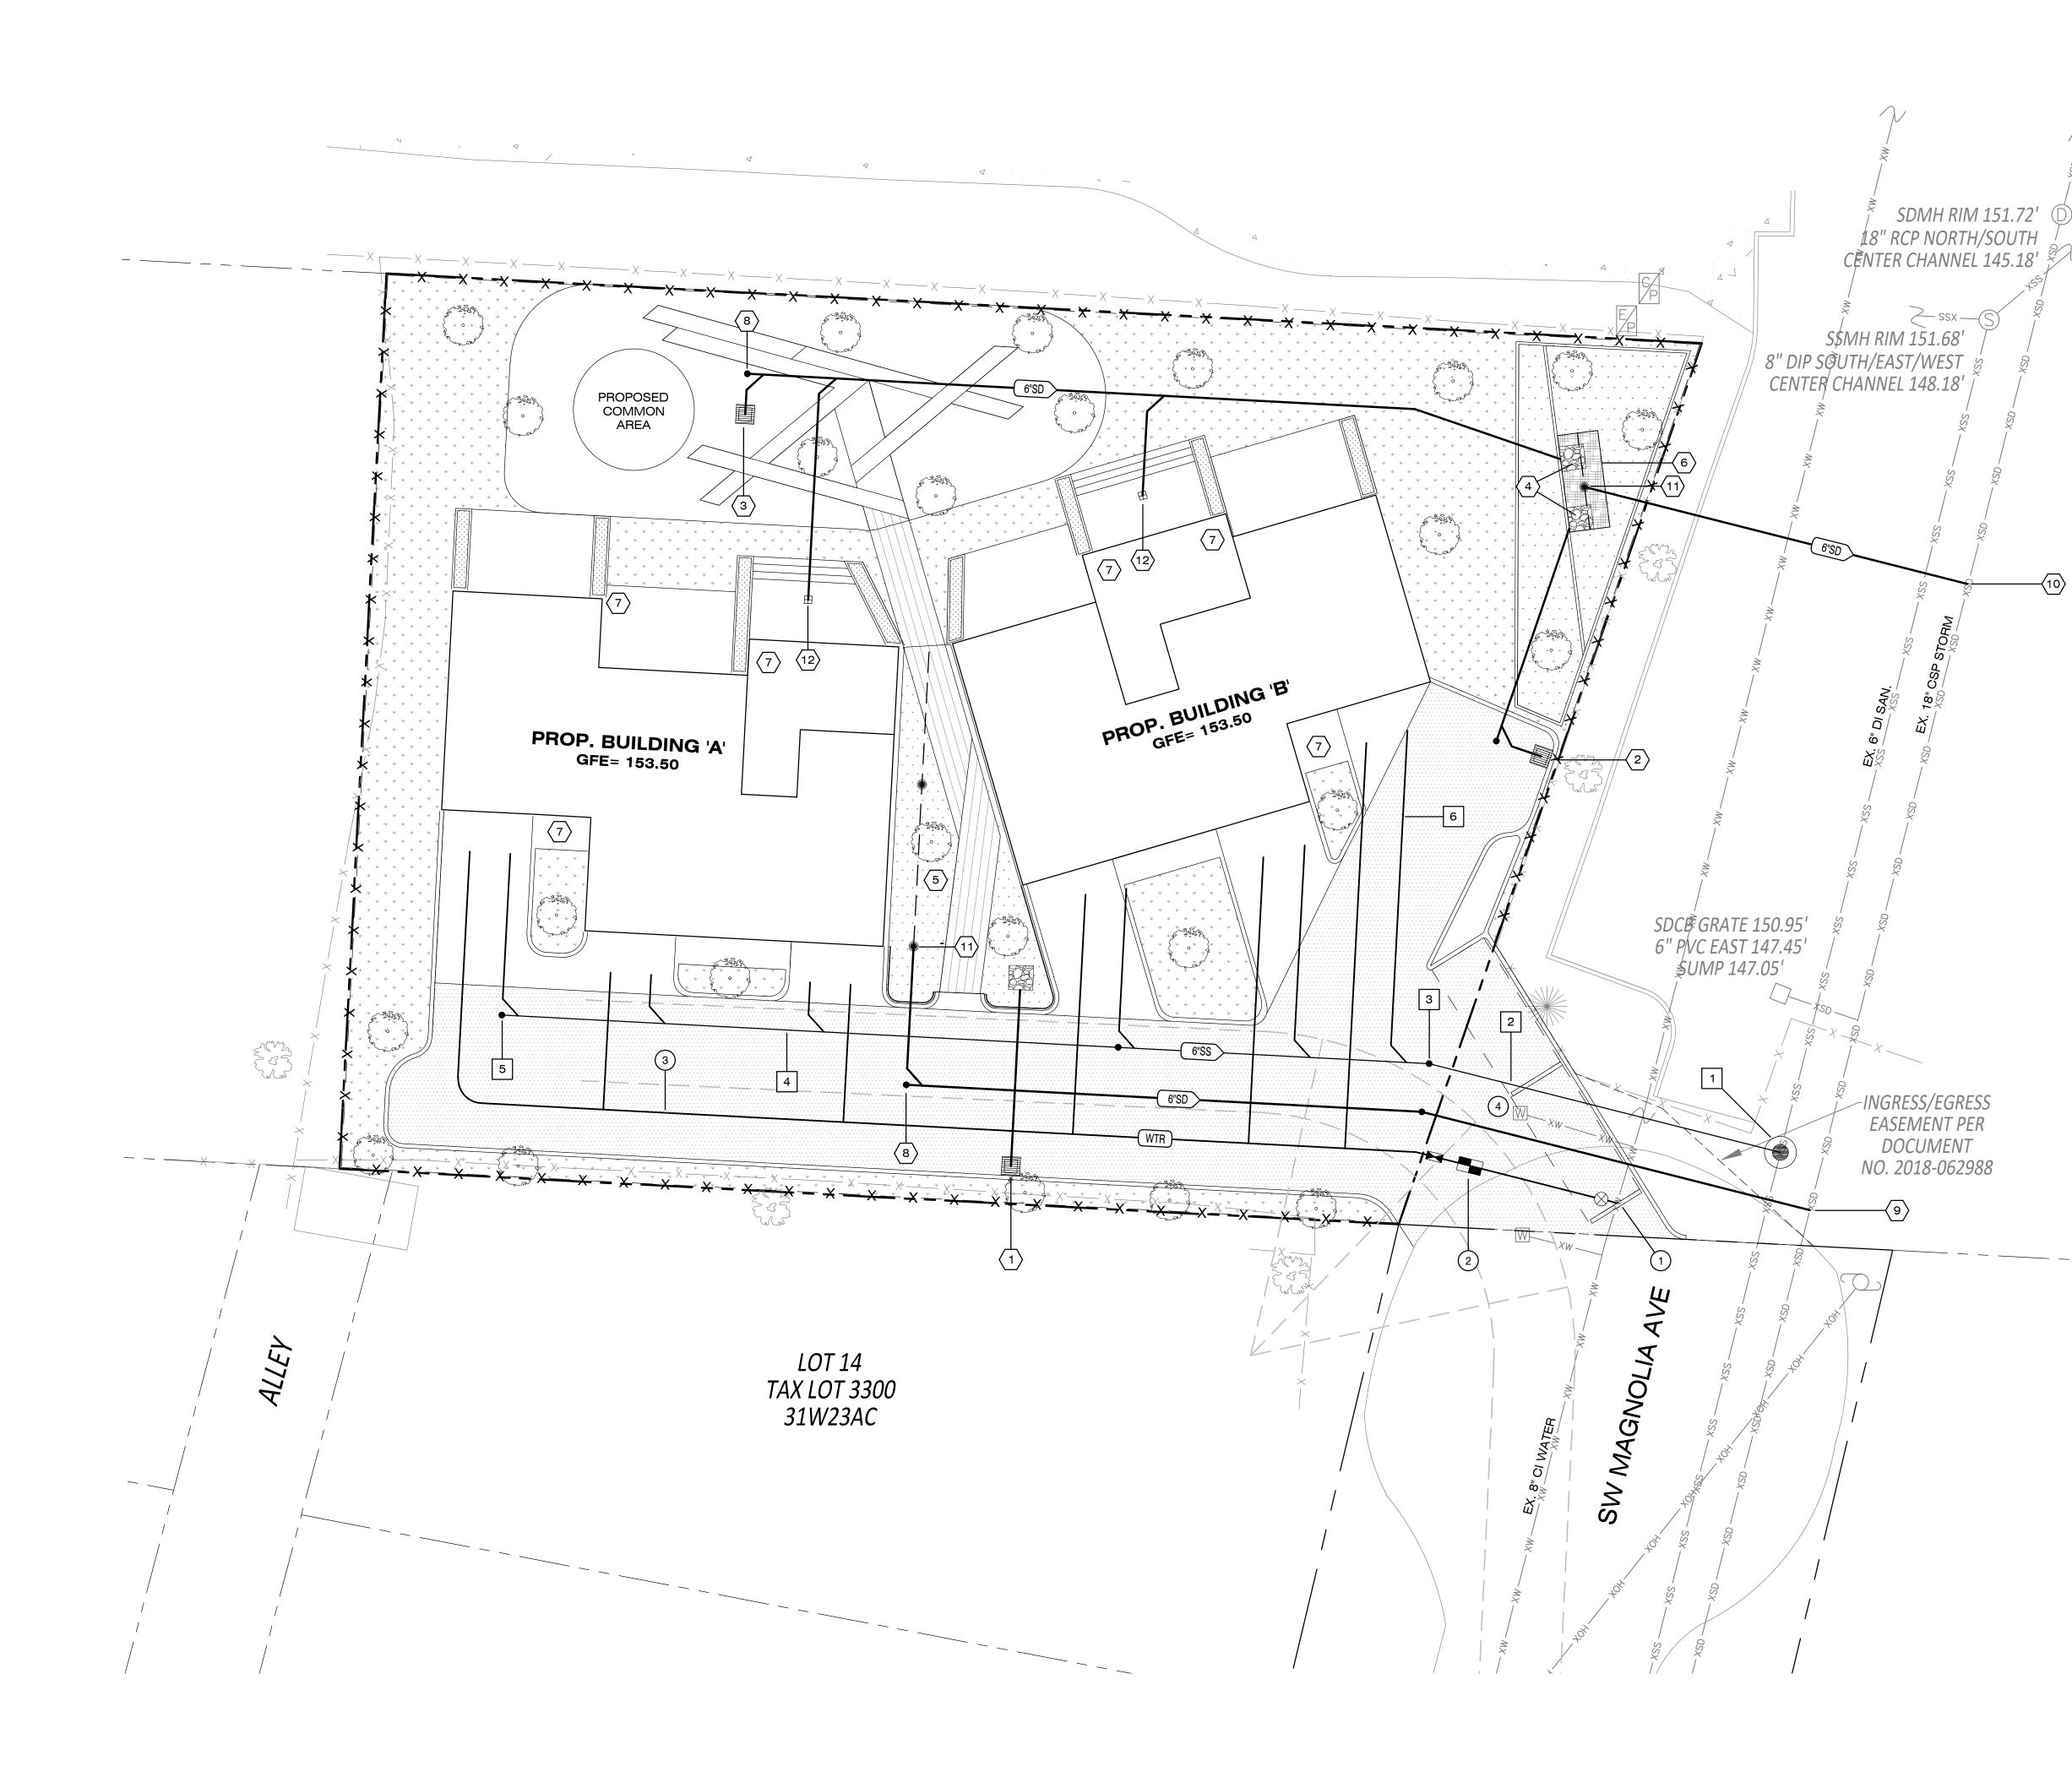

## LEGEND

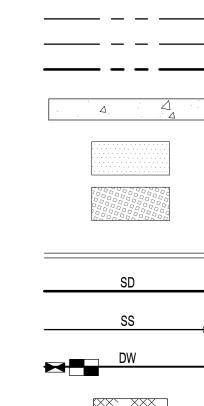

- PROPOSED RIGHT-OF-WAY ----- PROPOSED LOT LINE BOUNDARY LINE PROPOSED SIDEWALK PROPOSED PAVEMENT PROPOSED CONCRETE PAVEMENT PROPOSED CONCRETE CURB - PROPOSED STORM LINE PROPOSED SANITARY LINE & MANHOLE 

PROPOSED PRIVATE LIDA FACILITY

## WATER NOTES

- (1) CONNECT TO EXISTING 8" CI WATER MAIN.
- 2 INSTALL 1 ¹/₂" WATER SERVICE, METER AND BACKFLOW PREVENTER. SIZE TO BE DETERMINED BY FINAL FIXTURE UNIT COUNT.
- (3) INSTALL ±320 LF OF PEX PIPING (WIRSBO) TO SERVICE EACH UNIT PER UNIFORM PLUMBING CODE STANDARDS.
- 4 REMOVE EXISTING WATER METER AND SERVICE. RETURN TO CITY FOR CREDIT.

## SANITARY NOTES

- INSTALL PROPOSED MANHOLE OVER EXISTING SEWER MAIN PER CITY OF WILSONVILLE STANDARDS. RIM: 151.41 IE IN (6"W): 144.77
- IE OUT (EX. 6" N/S): 147.57
- 2 INSTALL 45 LF 6" PVC SS PVC D-3034 @ S=0.0100 FT/FT.
- 3 INSTALL 6" CLEANOUT RIM: ± 152.28


IE: 148.22

- 4 INSTALL 144 LF 6" PVC SS PVC D-3034 @ S=0.0100 FT/FT
- 5 INSTALL 6" CLEANOUT RIM: ± 153.01 IE: 149.36
- 6 SERVICE LATERALS TO EACH UNIT SHALL BE 6" PVC SS D-3034 @ S=0.0100 FT/FT, TYP.

## **STORM NOTES**

- CONSTRUCT TRAPPED CATCH BASIN.INSTALL 21.8 LF 6" DI @ S=0.0100 FT/FT RIM: 151.80 IE OUT (6"N): 150.30
- 2 CONSTRUCT TRAPPED CATCH BASIN. INSTALL 34.3 LF 6" DI @ S=0.0364 FT/FT RIM: 152.60
- IE OUT (6"W): 150.60
- CONSTRUCT TRAPPED CATCH BASIN.INSTALL 106.1 LF 6" DI @ S=0.0100 FT/FT RIM: 152.00 IE OUT (6"E): 150.41
- $\langle 4 \rangle$  INSTALL 6"-8" ROUND RIVER ROCK ENERGY DISSIPATER.
- CONSTRUCT PLANTER (BOTTOM AREA: ±580 SF) WITH 6"PERFORATED PIPE AND 6" OVERFLOW. LANDSCAPE PLANS BY
- OTHERS. 6 CONSTRUCT RAIN GARDEN (BOTTOM AREA: ±60 SF) WITH 6" PERFORATED PIPE AND 6" OVERFLOW. LANDSCAPE PLANS BY
- OTHERS. CONNECT DOWNSPOUTS FROM BUILDING AND DISCHARGE INTO PLANTER.
- 8 INSTALL 6" CLEANOUT, TYP.
- (9) CONNECT TO EXISTING 18" CSP STORM MAIN USING A 6" INSERT TEE. IE MAIN (EX. 18" N/S): 144.35 IE 6" (W): 144.85
- CONNECT TO EXISTING 18" CSP STORM MAIN WITH 6" INSERT TEE. IE MAIN (EX. 18" N/S): 144.88 IE 6" (W): 145.38
- $\langle 11 \rangle$  INSTALL LIDA FACILITY FLOW CONTROL STRUCTURE.
- $\langle 12 \rangle$  INSTALL 12" SQ AREA DRAIN OR TRENCH DRAIN.



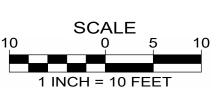



9020 SW WASHINGTON SQ. RD. SUITE 170 PORTLAND, OREGON 97223 P 503.643.8286 www.pd-grp.com



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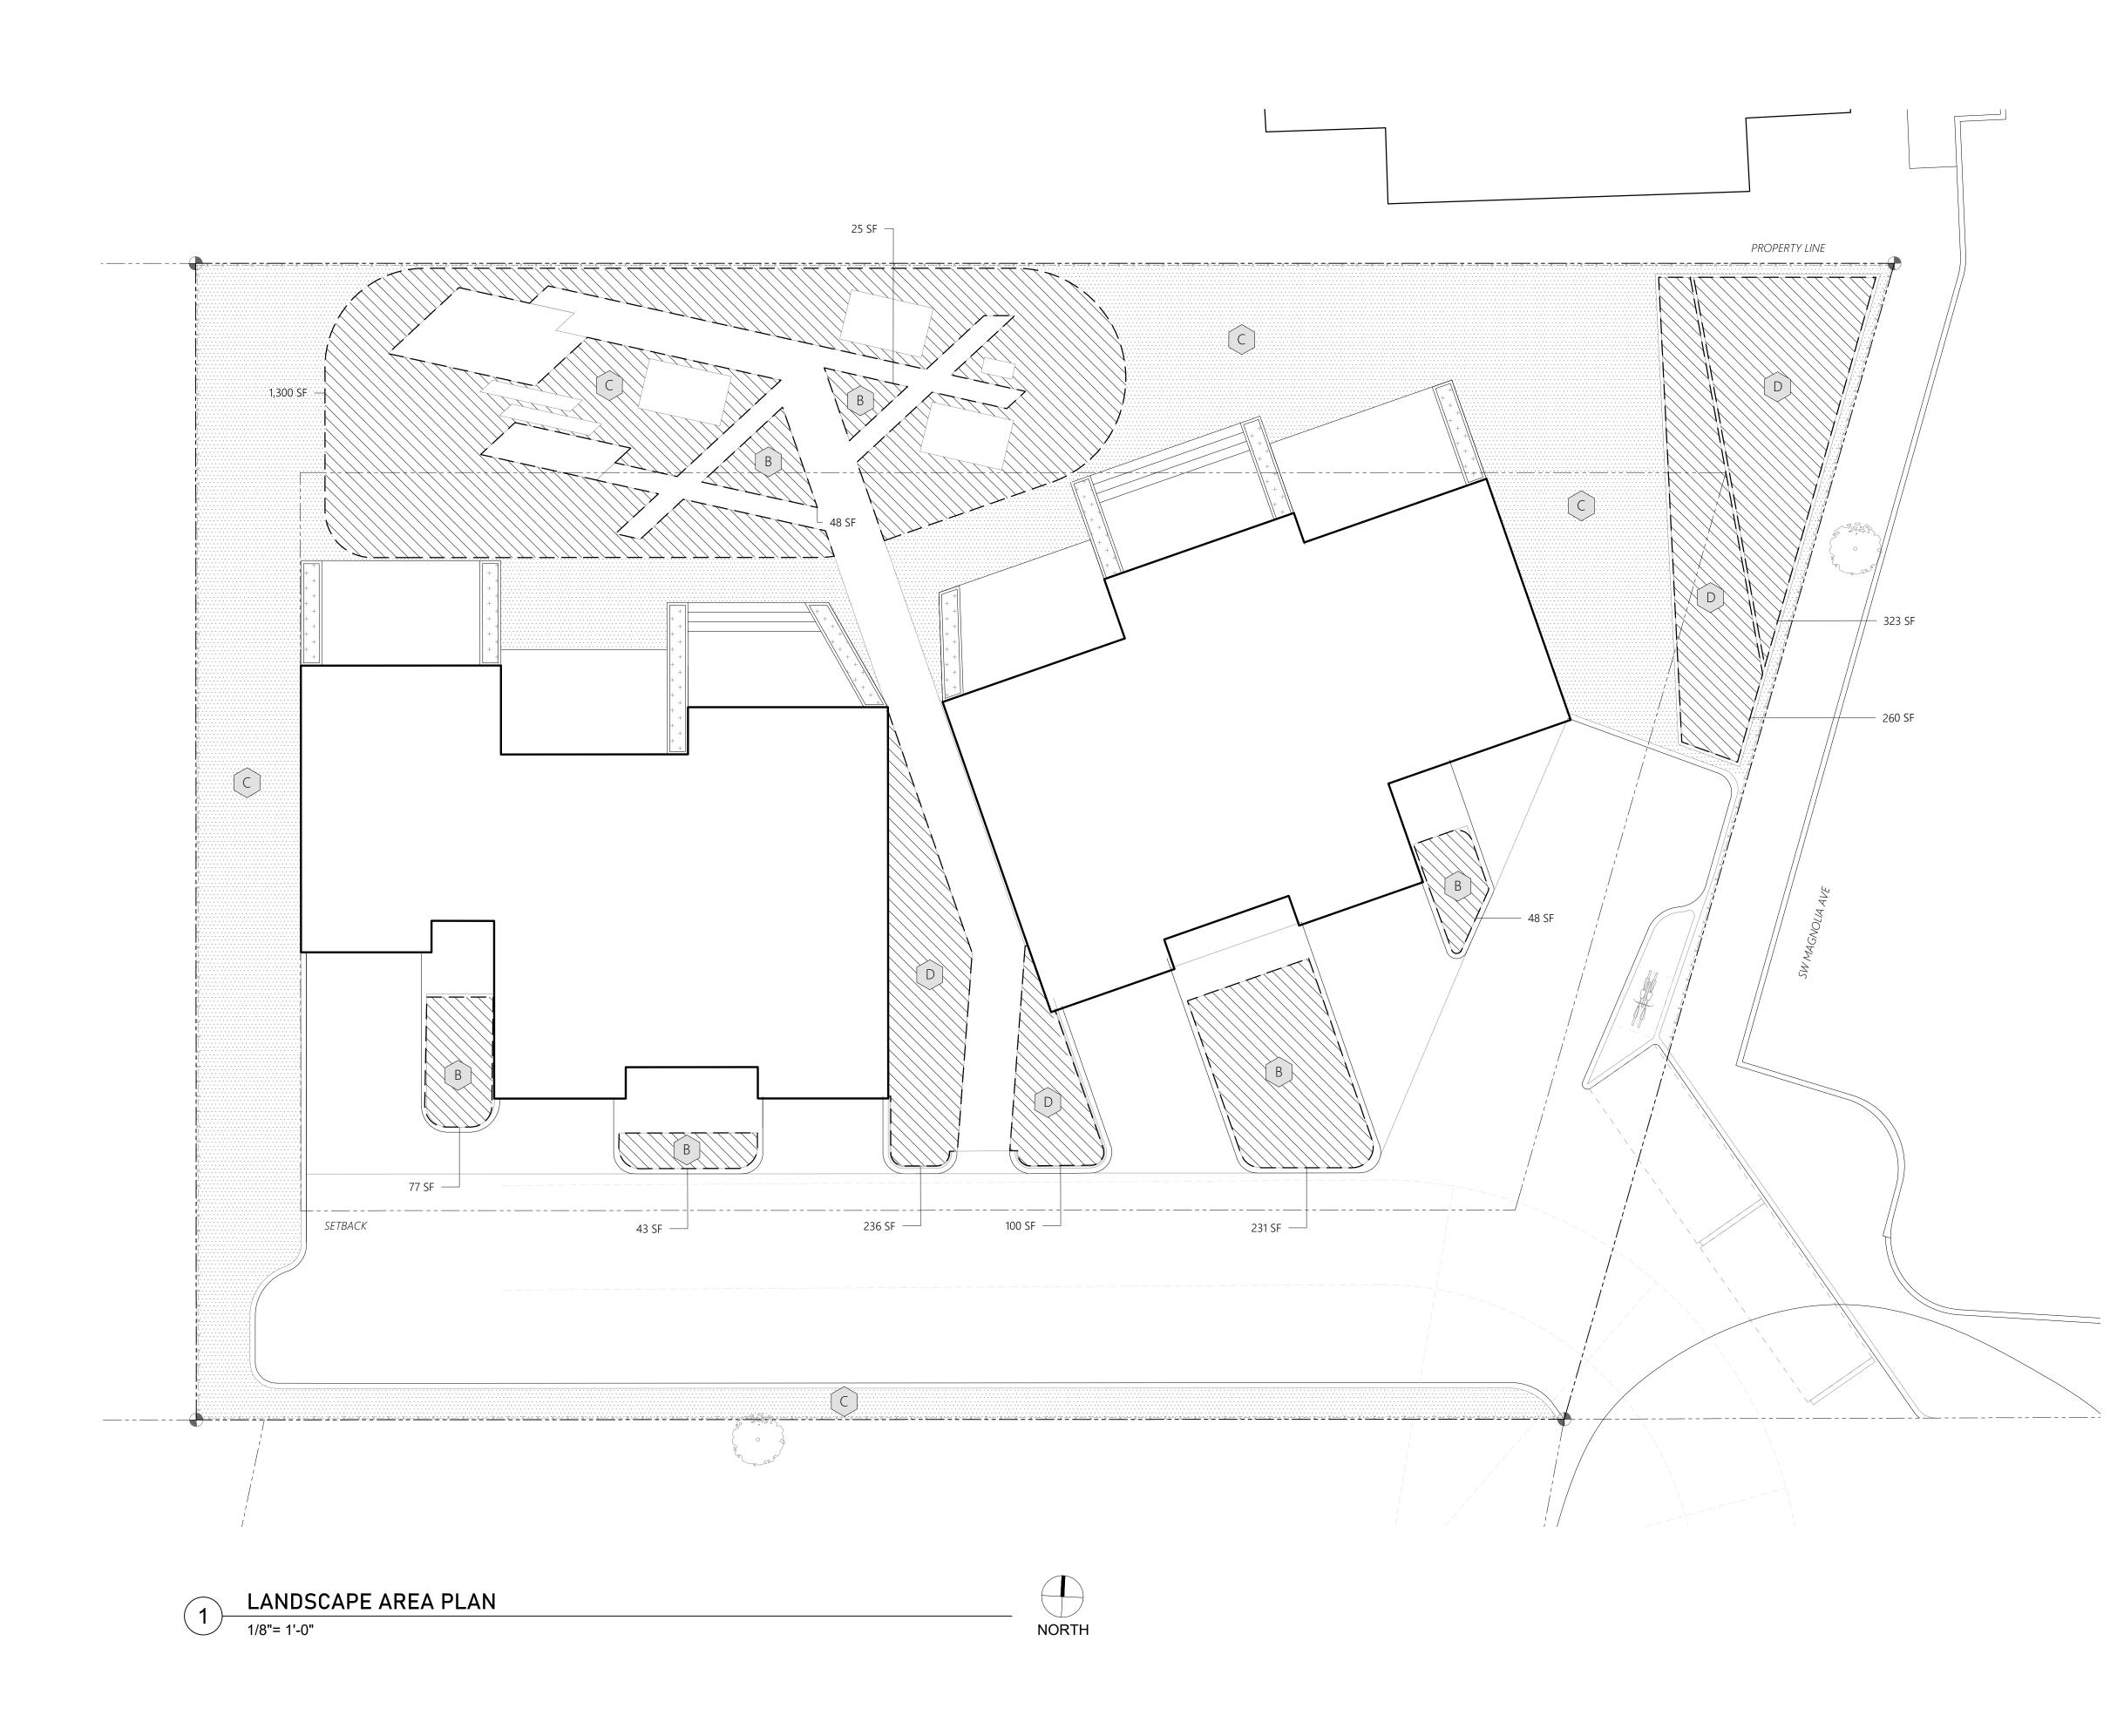
#### **LUR Revised Set** 07.17.2020


Revision Date: Issue:









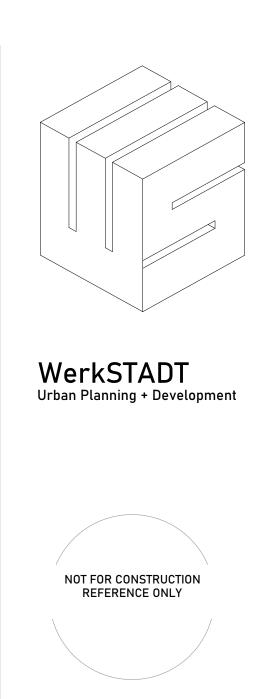

#### 15% LANDSCAPED AREA REQUIREMENT (2,500 SF)

LANDSCAPED AREA PROPOSED: 2,690 SF

#### ADDITIONAL LANDSCAPED AREA*

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NATURAL, DROUGHT-TOLERANT PLANTING.

 * FINAL PLANTING IN RAISED PLANTERS.
 * FINAL PLANTING LAYOUT IN LANDSCAPED AREAS OUTSIDE OF THE 15% REQUIRED LANDSCAPED AREA MAY VARY IN FINAL DOCUMENTS.

#### WATER USE ZONES

- A HIGH WATER USE, +/- 2 INCH/ WEEK
- B C
- B MODERATE WATER USE, +/- INCH/ WEEK
- LOW WATER USE, <1 INCH/ WEEK
- IRREGULAR WATER USE ZONE: STORMWATER TREATMENT FACILITY/ RAINGARDEN. [LOW WATER USE AND INUNDATION].




JOB:

30535 SW Magnolia Avenue Wilsonville, Oregon 97070

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SET ISSUE:

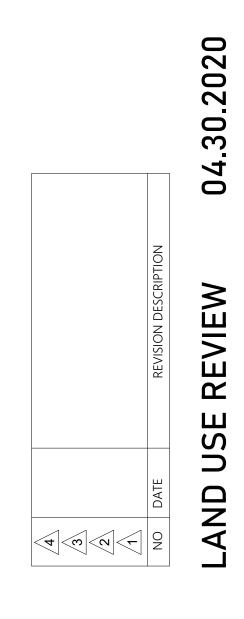


DRAWING SCALE: 1/8" = 1"

SHEET TITLE:

Landscape Area Plan

SHEET NUMBER:



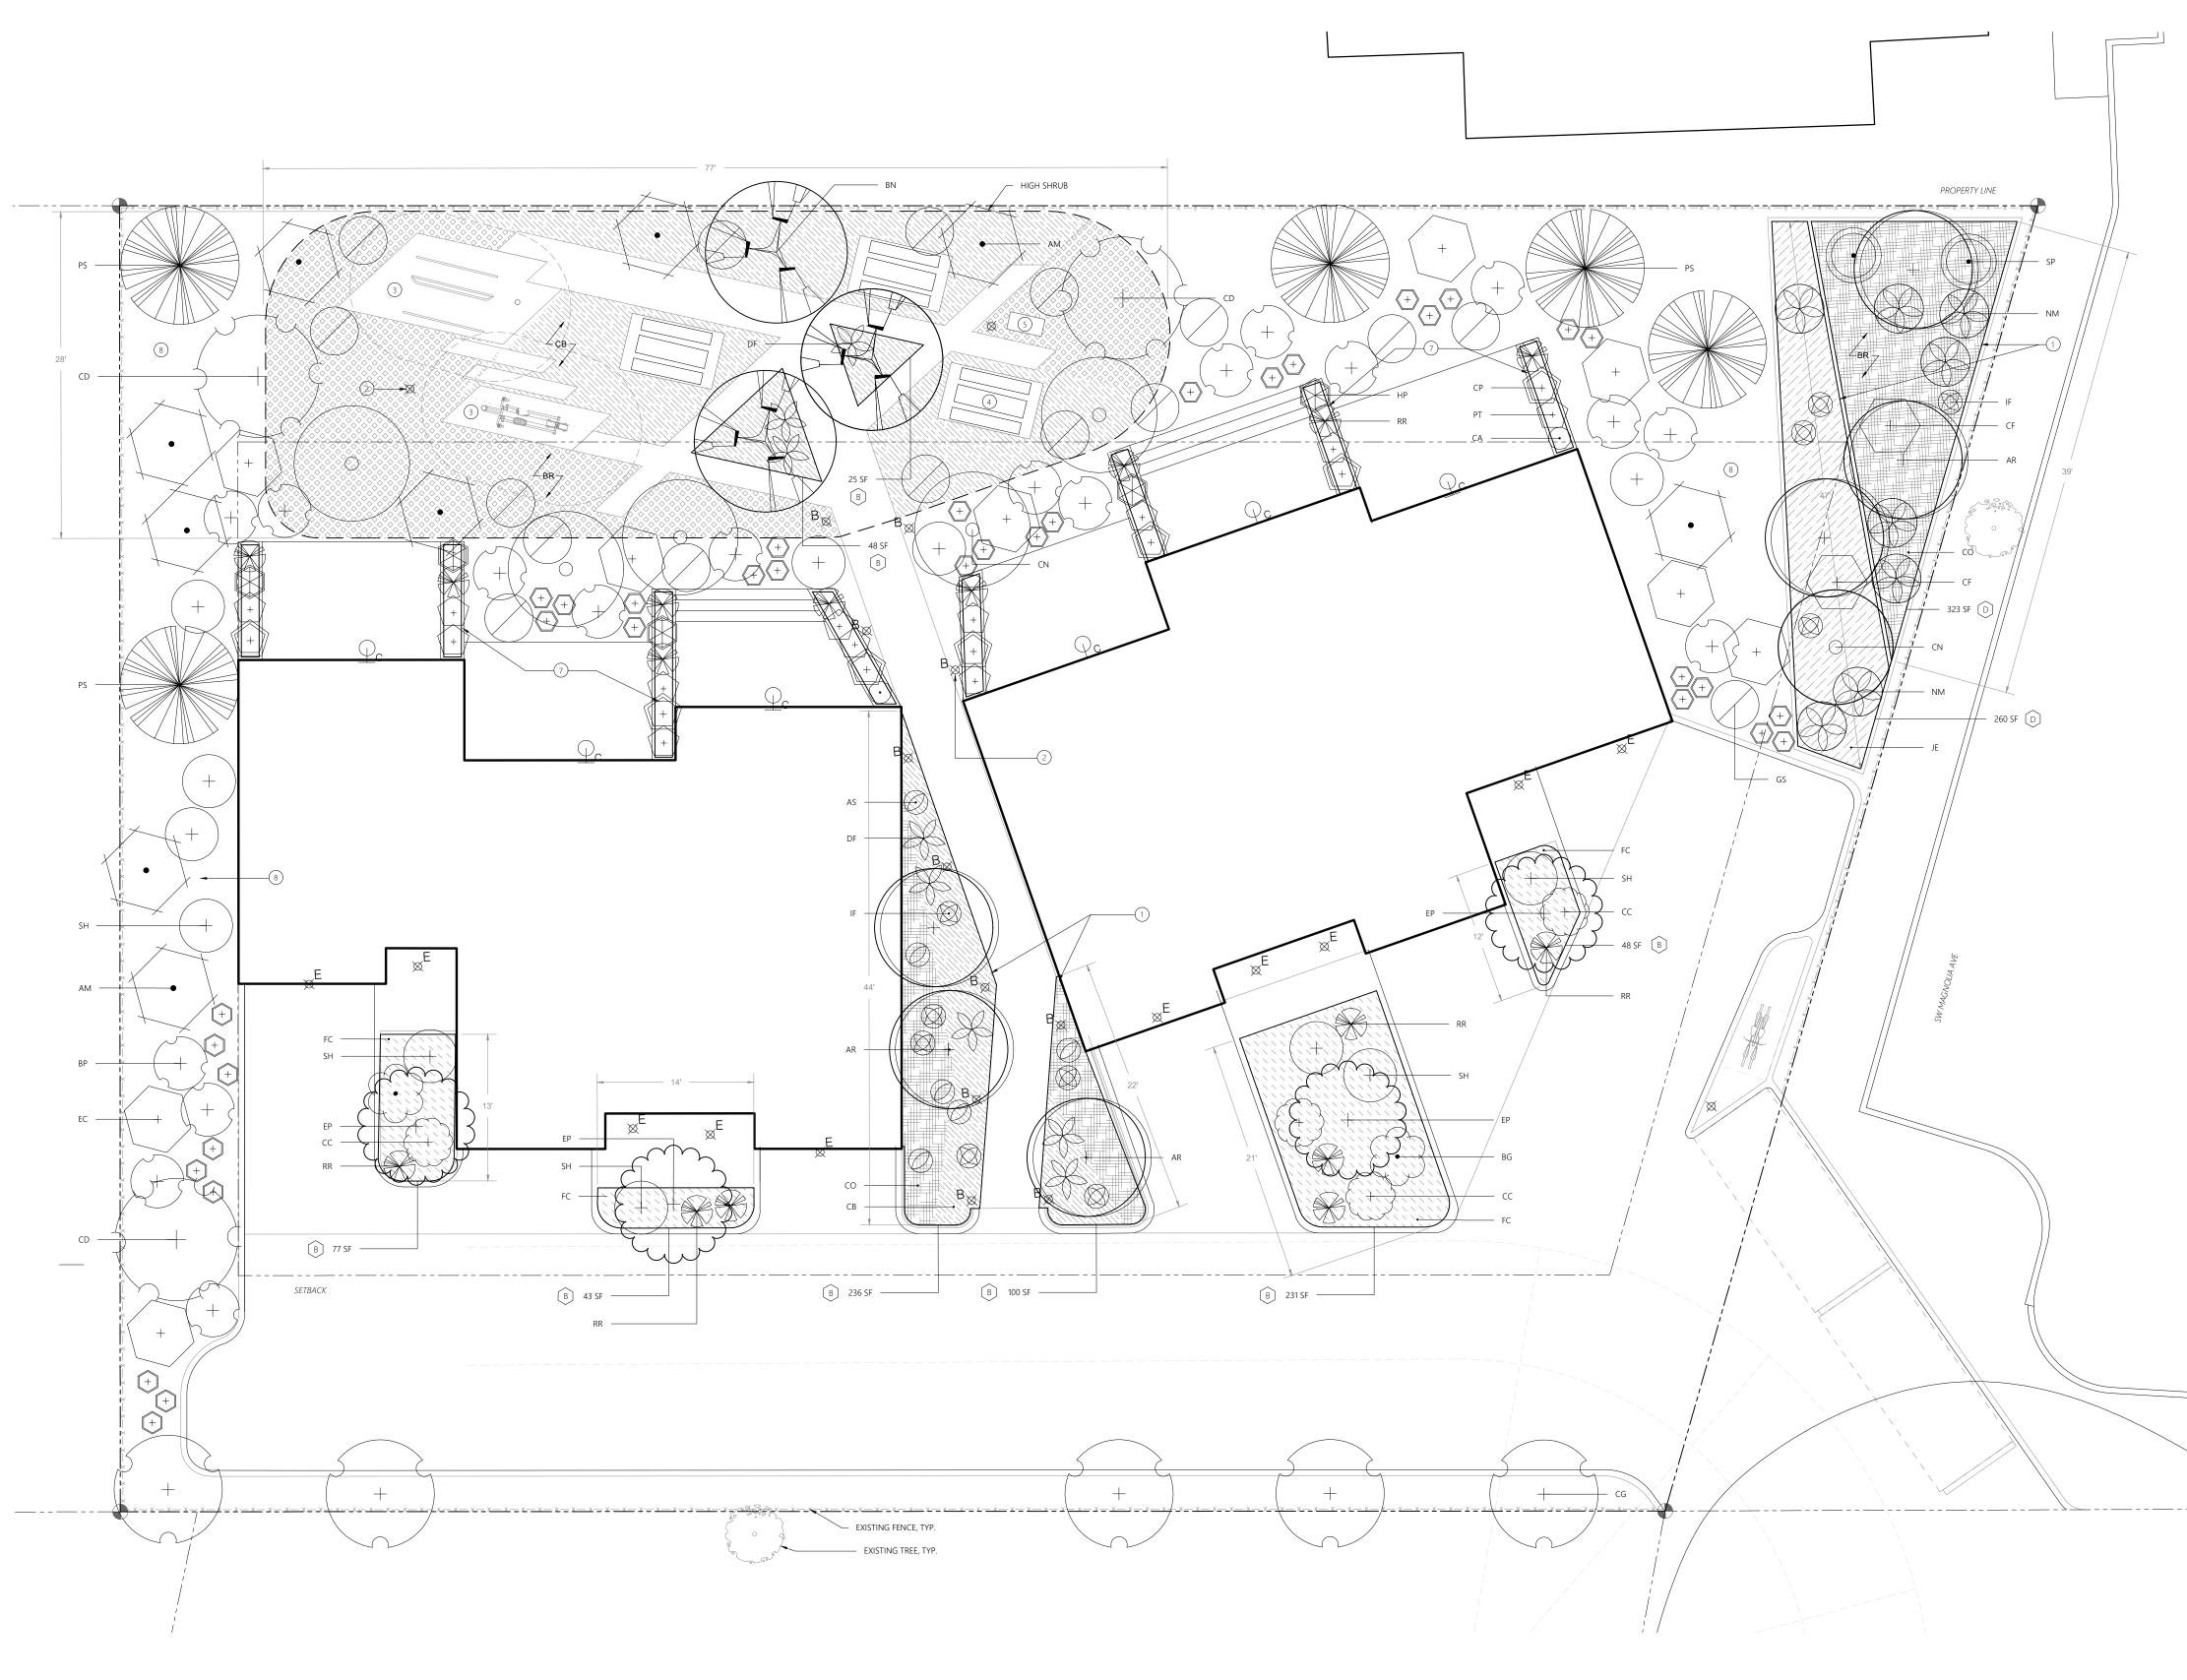

LANDSCAPE PLAN

1/8"= 1'-0"




#### PLANTING NOTES

- (1) STORMWATER MANAGEMENT FACILITY, SEE CIVIL.
- (2) SITE LIGHTING, SEE ARCHITECTURAL DRAWINGS.
- FITNESS STATIONS, RECREATIONAL COMMON AREA, SEE ARCHITECTURAL DRAWINGS. (3)
- 4 PICNIC COMMON AREA, SEE ARCH DRWGS.
- (5) GRILL, COMMON AREA, SEE ARCH DRWGS.
- 6 RAISED WALKWAY, SEE ARCHITECTURAL DRWGS.
- 7 ORNAMENTAL PLANTING IN RAISED PLANTERS AT PRIVATE PATIOS.
- 8 NATURAL, DROUGHT-TOLERANT PLANTING.

#### WATER USE ZONES

- A HIGH WATER USE, +/- 2 INCH/ WEEK
- MODERATE WATER USE, +/- INCH/ WEEK B
- LOW WATER USE, <1 INCH/ WEEK
- IRREGULAR WATER USE ZONE: STORMWATER [D] TREATMENT FACILITY/ RAINGARDEN. [LOW WATER USE AND INUNDATION].

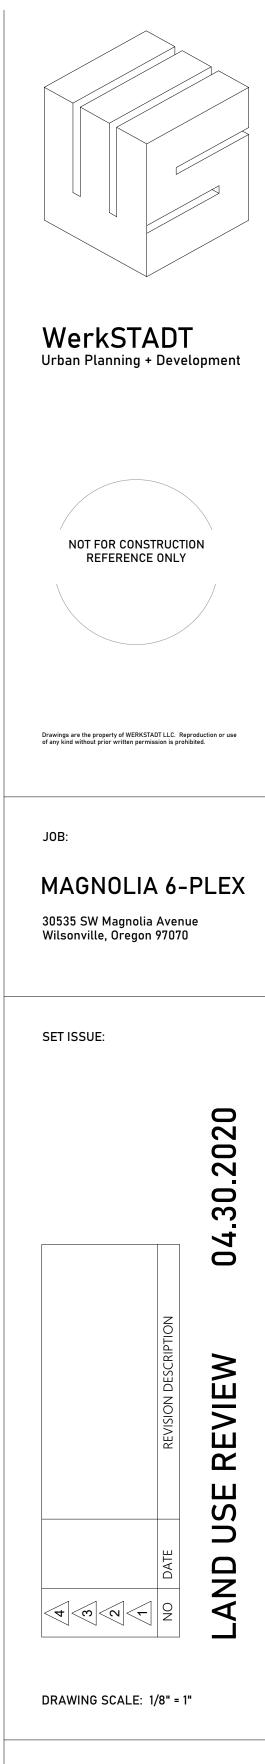

SHEET TITLE:

## Landscape Plan


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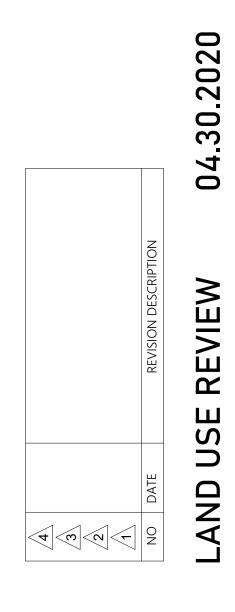


PLANT IDENTIFICATION			PLANT SIZE		PLANTIN	IG SPECIFICATIO	ON		ATERIAL CH	ARACTER	ISTIC	S			
CODE	SCIENTIFIC NAME	COMMON NAME	Height / Tree size	Spread	Spacing O.C.	Container, Caliper/ Height	Quantity	Drought Tolerant	Water Consumption	Rain Garden	Nativ	/e	Evergr	een	
TREES	Primary					-									
AR	Alnus rubra	Red Alder	60'-80' (S)	40'		B & B / 2″	6		Low	(2)		Ν		(4)	
BN	Betula nigra 'BNMTF'	Dura-heat River Birch	70' (S)	50'		B & B / 2″	3		Moderate	(2)				(4)	
EP	Eucalyptus pauciflora spp. niphophila	Snow Gum	35' (S)	35'		B & B / 2"	4	(1)	Zero				Е		(5)
TREES	Accent		1		1										
CN	Cornus nuttali	Pacific Dogwood	50' (S)	20'		B & B / 1.75″	6	(1)	Very Low		(3)	NWV		(4)	
CD	Cedrus deodara	Deodar Cedar	60' (L)	35'		B & B /8' HT	3		Moderate						(5)
CG	Cupressus arizonica var. glabra 'Blue Ice'	Blue Ice Arizona Cypress	15' (S)	8'-12'		B & B / 6' HT	5	D	Very Low				E		
PS	Pinus sabiana	Foothill Pine	40'-80' (L)	10'-30'		B & B / 8' HT	5	(1)	Zero			Ν	Е		
SHRUBS	l High														
	Arbutus menziesii	Pacific Madrone	25'-60'	50'		5 gal	9	(1)	Zero		(3)	NWV	E	(4)	
CF	Cornus sericea	Red Twig/Osier Dogwood	6'+		6'		2	D	Moderate	(2)		NWV	_	(4)	(5)
SHRUBS						- 8				(_/	(-)			( )	(-7
BG	Baeckea gunniana	Alpine Baekckea	3'		4'	2 gal	2	D	Low				E		
BP	Baccharis pilularis	bwarf Coyote Brush	2'		5'	0	18	D	Very Low		(3)	NWV	E		
СС	Carpenteria californica	Bush Anemone	3'-5'		4'	-	3	(1)	Zero				E		
СР	Callistemon pityoides 'Moonlight'	Bottlebrush	3'		4'	-	8	D	Very Low				E		
GS	Gaultheria shallon	Salal	1'-5'		5'	2 gal	13	(1)	Moderate		(3)	NWV	Е	(4)	
NM	Nandina domestica 'Moon Bay	Heavenly Bamboo	3'		2'	2 gal	8	(1)	Zero	(2)			E	(4)	(5)
PT	Phormium tenax 'Pink Stripe'	New Zealand Flax	4-5'		3'	2 gal	12		Low				Е		
RR	Rosmarinus officinalis 'Irene'	Rosemary	1'-2'		4'	2 gal	16		Very Low				Е		
SP	Salix purpurea 'Nana'	Dwarf Alaskan Blue Willow	4'		5'	2 gal	2		Moderate	R				(4)	
SH	Sarcococca hookerana var. humilis	Sarcococca (Sweetbox)	3'-4'		3'	2 gal	9	(1)	Moderate				Е		(5)
Groundco	ver														
AS	Asclepias speciosa	Showy Milkweed	3'		36"	4″ pot	6		Low	R	(3)	NW			
AU	Arctostaphylos uva-ursi	Kinnickinnick	8″		12″	4" pot	36	D	Very Low	(2)	(3)	NWV	Е	(4)	(5)
BR	Berberis repens	Creeping Oregon Grape	18″		24″	4″ pot	180*		Low	(2)		NW	Е		(5)
CA	Clematis amandii	Evergreen clematis	10'		24″	1 gal	2	(1)	Moderate				E		
СВ	Carex athrostachya	Slenderbeaked Sedge	1'		12″	4" pot	1000*		Moderate			Ν		(4)	
со	Carex Obnupta	Slough Sedge	3'-4'		12″	4" pot	557*		Moderate	(2)		NW	Е	(4)	(5)
DF	Dryopteris filix-mas	Male Fern	2'		24″	1gal	8	(1)	Zero			Ν		(4)	
EC	Erica carnea	Winter Heath	1′		24″	4" pot	9	(1)	Moderate				Е		
FC	Festuca california	California fescue	2-3'		24″	4" pot	115*	D	Very Low		(3)	NWV	E	(4)	
HP	Hesperaloe parviflora 'Arizona Sunrise'	Arizona Sunrise False Yucca	3'-4'		24″	1 gal	5		Low				Е		
IF	Iris foetidissima 'Citrina'	Gladwin Iris	2'		18"	4″ pot	10	(1)	Zero			Ν			
JE	Juncus effusus spp. Pacificus	Pacific Sedge / Soft Rush	1'-3'		36"	4" pot	33*		Low	R	(3)	NWV	Е	(4)	
КМ	Koeleria macrantha	Prairie Junegrass	1-2'		24″	4" pot	20		Very Low		(3)	NWV		(4)	



# 30535 SW Magnolia Avenue Wilsonville, Oregon 97070

SET ISSUE:

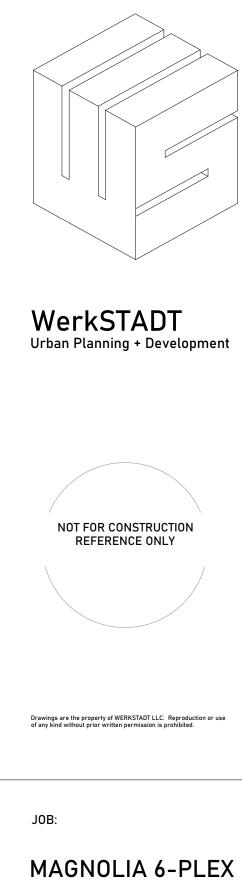

DRAWING SCALE: 1/8" = 1"

SHEET TITLE:

Plant Material List

#### SHEET NUMBER:



#### Planting Notes

- (1) Suggested Xeriscape Plant Palette: Guidelines for a Water Wise Landscape, City of Wilsonville
- (2) Stormwater Management Manual, City of Portland Bureau of Development Services
- (3) Native Plants for Willamette Valley Yards, Metro and local partners
- (4) Portland Plant List, City of Portland
- (5) Landscape Manual, City of Portland
- Groundcover plant quantities represent estimates based on preliminary * planting design layout areas, triangular O.C. spacing, and estimate formula.

#### Abbreviations

- E Evergreen
- R Rain Garden species
- D Drought Tolerant
- N Native
- NW Northwest Native
- NWV Willamette Valley Native
- O.C. On center spacing, triangular layout
- S/ M/ L Small/ Medium/ Large